

		GENERAL NOTES 1. TAX MAP DESIGNATION: SECTION 207, BLOCK 5, LOT 25
ements		19 WELLING PLACE, WARWICK, NY 10990 2. RECORD OWNER / APPLICANT:
Existing	Proposed	CHARLIE & PATTI BOSSOLINA 21 UNION CORNERS ROAD
5220.5 sq. ft. Automobile sales and service / (o) Gasolie	5220 sq. ft. Business / Professional /	WARWICK, NY 10990 3. PROPERTY AREA: 0.09 ± ACRES
Service Station (o) Residences on 2nd & 3rd	Government (j) Residences on 2nd & 3rd	 ZONING DISTRICT: CENTRAL BUSINESS (CB) EXISTING WATER SUPPLY: VILLAGE OF WARWICK WATER SYSTEM
Floor of existing bldg. (j)	Floor of existing bldg. (j)	 EXISTING SEWAGE DISPOSAL: VILLAGE OF WARWICK SEWER SYSTEM SURVEY INFORMATION PROVIDED BY JOHN A. MCGLOIN, DATED JANUARY 11, 2024. TOPOGRAPHY INFORMATION TAKEN FROM ORANGE COUNTY
3902	Unchanged	IMAGE MATE. 8. EXISTING USE: AUTOMOTIVE REPAIR GARAGE & APARTMENTS
72.71 3.7 feet	Unchanged Unchanged	9. PROPOSED USES: PROFESSIONAL OFFICES & APARTMENTS
N/a 5.9	N/a Unchanged	
13.1 7.2	Unchanged Unchanged	
N/a	Unchanged	
4.8 4.8	Unchanged Unchanged	
N/a	Unchanged	
72.71 feet 31.66 feet	Unchanged	
lowest grade to ridge	less than 35 feet	
73%	Unchanged	
67%	Unchanged 1.33	
54 feet	Unchanged Minimum 815 sq. ft.	
	Maximum 848 sq. ft.	
N/a N/a	N/a N/a	
Note 3: Efficiency - 400 sq ft, One bedroom - 550 sq ft, Two bedroom - 750 sq ft	Building Area: 2626.21 sq. ft. Lot Area: 0.90 Acres or	
	3920.4 square Feet Current Floor Area: 4432 sq.	
	ft. Proposed Floor Area: 5252 sq. ft.	
Note 4: Lot area shall be defined in § 145-181 for	Lot Area: The total horizontal area included within the	
columns 2, 15, 15A, 19 and 20 per Local Law #1 of 2001.	property lines of a lot, after it has been adjusted as set forth in § 145-42A.	
		VICINITY MAP
WER STWEE		SCALE: 1" = 200'±
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		MUNICIPAL PARKING AREA
		Et UN SINGY
		MUNICIPAL PARKING AREA
``````````````````````````````````````		PROJECT SITE
Ì		(207–5–25)
		MELLING PL.
$\langle \cdot \rangle$		NG R.
		5. S.
		CENTRAL BUSINESS
		(СВ)
		MUNICIPAL PARKING AREA
CESS		
DOR S		301/09/25VILLAGE OF WARWICK PLANNING BOARD FINAL SIGNATURE211/18/24VILLAGE OF WARWICK PLANNING BOARD REVIEW
MANHO	LE	1 10/15/24 VILLAGE OF WARWICK PLANNING BOARD REVIEW
IS DOCUMENT		ISSUE DATE DESCRIPTION
ACTUAL OR THE	TATE OF NEW YOU	SITE PLAN
SIGNATURE SINAL STAMP D SEAL SHALL	* SQUAR COLOR 27	
RED INVALID.	LIG LIGHT HE	BOSSOLINA PROPERTY
ED S OR	35-5 105494 E	SECTION 207 BLOCK 5 LOT 25 VILLAGE OF WARWICK
O THIS EARING THE	POFESSIONAL	ORANGE COUNTY, NEW YORK
CENSED	Office	
ON OF 9 SUBSECTION	0	FRIEDLER ENGINEERING, PLLC
V YORK STATE AW. NE	BRIAN FRIEDLER, P.E. EW YORK LICENSE # 105494	PH. 845.544.5662
GRAPHIC		9 LOCUST STREET WARWICK, NEW YORK 10990
		FRIEDLERENGINEERING@OUTLOOK.COM
1" = 1	10'	DRAWN BYCHECKED BYSCALEJOB NO.SHEET NO.BJFBJFAS SHOWNFE-241481 OF 2

## SANITARY SEWER NOTES:

1. CONTRACTOR TO VERIFY LOCATION, LENGTHS, INVERTS, FEATURES AND CONDITIONS OF ALL SANITARY MANHOLES, PIPELINES, ETC AND SHALL IMMEDIATELY NOTIFY THE DESIGN ENGINEER AND APPLICANT OF ANY DISCREPANCIES.

2. ALL SANITARY SEWER LATERALS, MATERIAL AND PROCEDURES OF CONSTRUCTION WILL BE IN ACCORDANCE WITH ALL THE REQUIREMENTS OF THE VILLAGE OF WARWICK SEWER DEPARTMENT. NO INSTALLATION OF PIPE LINES OR RELATED EQUIPMENT SHALL BE INSTALLED WITHOUT PRIOR WRITTEN APPROVAL OF THE VILLAGE OF WARWICK.

3. ALL PIPES SHALL BE INSTALLED IN CONFORMANCE WIT THE PLANS AND FIELD CONDITIONS. ALL NEW SEWER PIPES SHALL BE A MINIMUM 6" SDR-35 PVC PIPE OR APPROVED EQUAL.

4. ALL TESTING SHALL BE ACCORDING TO THE VILLAGE OF WARWICK SEWER DEPARTMENT REQUIREMENTS.

## WATER SERVICE NOTES:

1. CONTRACTOR TO VERIFY LOCATION, LENGTHS, INVERTS, FEATURES AND CONDITIONS OF ALL SANITARY MANHOLES, PIPELINES, ETC AND SHALL IMMEDIATELY NOTIFY THE DESIGN ENGINEER AND APPLICANT OF ANY DISCREPANCIES.

2. ALL WATER MAIN LATERALS, MATERIAL AND PROCEDURES OF CONSTRUCTION WILL BE IN ACCORDANCE WITH ALL THE REQUIREMENTS OF THE VILLAGE OF WARWICK WATER DEPARTMENT. NO INSTALLATION OF PIPE LINES OR RELATED EQUIPMENT SHALL BE INSTALLED WITHOUT PRIOR WRITTEN APPROVAL OF THE VILLAGE OF WARWICK.

3. ALL PIPES SHALL BE INSTALLED WITH A MINIMUM  $4^{2}-6^{2}$  OF COVER. PIPES SHALL BE DUCTILE IRON PIPE OR APPROVED EQUAL

4. INSTALLATION AND PROCEDURES FOR COPPER WATER SERVICE PIPE WILL CONFORM WITH THE AMERICAN WATER WORKS ASSOCIATION.

5. ALL TRENCHES SHALL BE BACKFILLED ACCORDING TO THE PROVIDED DETAIL.

6. ALL BENDS AND TEES INSTALLATIONS SHALL BE SUITABLY RESTRAINED BY THE USE OF ADEQUATE THRUST BLOCKS, RODDING, RETAINER RINGS AND/OR THE USE OF SPECIAL GASKETS. 7. ALL TESTING AND DISINFECTION SHALL BE IN ACCORDANCE TO THE VILLAGE OF WARWICK

WATER DEPARTMENT OR ORANGE COUNTY DEPARTMENT OF HEALTH. 8. PROPOSED WATER SERVICE LINE TO BE 4" DUCTILE IRON PIPE OR APPROVED EQUAL.

9. 4" WATER SERVICE LINE SHALL HAVE A SPUR FOR DOMESTIC WATER WITH A BACKFLOW PREVENT. ALSO A BACKFLOW PREVENTER FOR THE FIRE SUPPRESSION SYSTEM.

> 5'-10" SLOPE W/ EXISTING STREET GRADES

4" OF 3500 PSI CONCRETE AIR ENTRAINED, WITH 6X6, 6 GA. WWM CENTERED IN THE SLAB.

- 4" COMPACTED R.O.B.

---- COMPACTED SUBGRADE

<u>NOTES:</u>


1. FINISH TO BE BROOM FINISH AT 90° TO EACH SUCEEDING SLAB.

2. JOINTER TO BE 1" DEEP. JOINT SPACING SHALL BE EQUAL TO WIDTH

OF WALK FOR SPACING. 3. INSTALL 1/2" PRE-MOLDED EXPANSION JOINT AT 24' O.C. AND WHERE

SIDEWALK IS AGAIST CONCRETE CURBS, BUILDINGS, AND OTHER STRUCTURES. CONCRETE SIDEWALK DETAIL

N.T.S

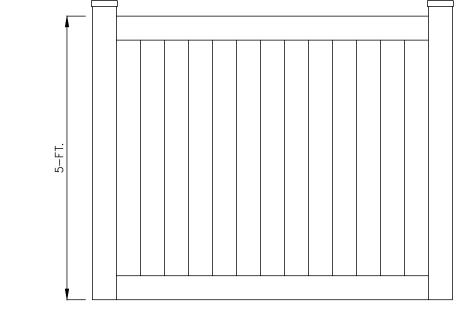

2" ASPHALTIC TOP COURSE-

NOTES:


NOTES:

3" ASPHALTIC BINDER COURSE-

STRAIGHT CUT

PARALLEL TO TRENCH

RESTORATION -PAVEMENT CUT

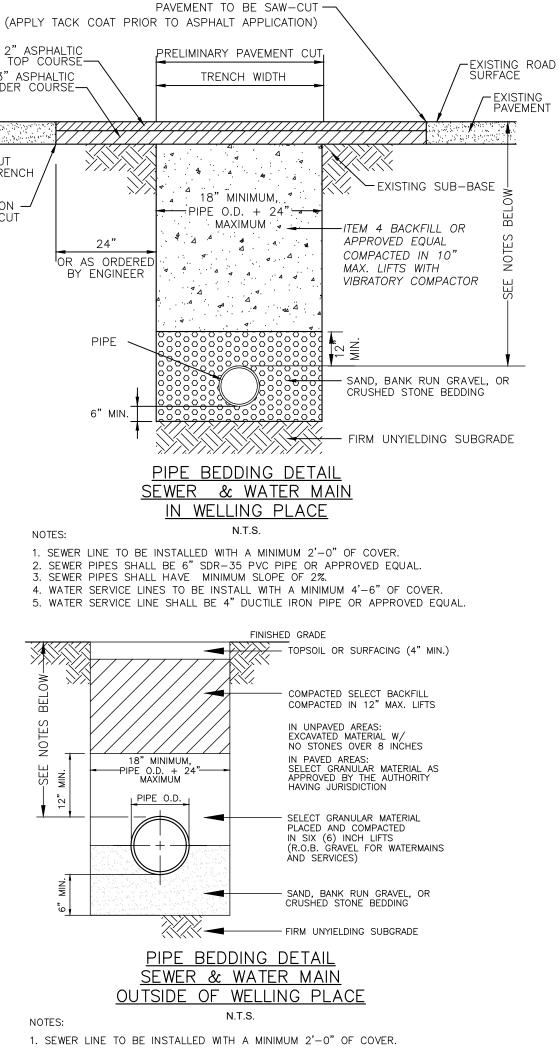


2. SEWER PIPES SHALL BE 6" SDR-35 PVC PIPE OR APPROVED EQUAL. 3. SEWER PIPES SHALL HAVE MINIMUM SLOPE OF 2%. 4. WATER SERVICE LINES TO BE INSTALL WITH A MINIMUM 4'-6" OF COVER. 5. WATER SERVICE LINE SHALL BE 4" DUCTILE IRON PIPE OR APPROVED EQUAL.

## SOIL EROSION CONTROL NOTES

1. SILT FENCE BARRIERS SHALL BE INSTALLED PRIOR TO CONSTRUCTION.

- 2. DISTURBANCE TO BE LIMITED TO THE MINIMUM NECESSARY FOR THE GRADING AND CONSTRUCTION OF THE PROPOSED IMPROVEMENTS.
- 3. TEMPORARY SEEDING WITH ANNUAL RYE GRASS OR OTHER RAPID GROWING MIXTURE SHALL BE PERFORMED ON DISTURBED SOIL REMAINING VACANT FOR MORE THAN ONE MONTH AS FOLLOWS: a. LOOSEN SEEDED BY DISCING TO 4" DEPTH.
- b. FERTILIZE AS PER SOIL TEST OR APPLY 5-10-10 FERTILIZER (20 lbs. per 1000 s.f.) c. SEED WITH PERENNIAL RYEGRASS (20 lbs. per 1000 s.f.) d. MULCH WITH STRAW MULCH (90 lbs. per 1000 s.f.)
- 4. ALL DISTURBED AREAS TO BE MULCHED TO PREVENT EROSION. THE CONTRACTOR SHALL COMPLY WITH ALL REQUESTS OF THE TOWN ENGINEER OR BUILDING INSPECTOR DURING CONSTRUCTION WITH REGARD TO EROSION CONTROL DEVICES.
- 5. EROSION CONTROL MEASURES SHALL REMAIN IN PLACE AND BE MAINTAINED BY THE CONTRACTOR UNTIL PERMANENT STABILIZATION HAS BEEN ESTABLISHED.

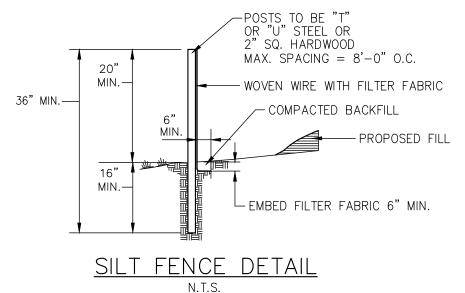

<u>NOTES:</u>

- 1. WHERE TWO SECTIONS OF FILTER CLOTH ADJOIN EACH OTHER, THEY SHALL BE OVERLAPPED BY SIX INCHES AND FOLDED.
- 2. MAINTENANCE SHALL BE PERFORMED AS NEEDED AND MATERIAL REMOVED WHEN "BULGES" DEVELOP IN THE SILT FENCE.
- 3. SILT FENCE FABRIC TO BE MIRAFI 100X OR APPROVED EQUAL.
- 4. WOVEN WIRE FENCE (MIN. 14.5 GAUGE, MAX 6" MESH SPACING)

<u>APPROVED FOR F</u>	ILLING:	COPIES C WITHOUT FACSIMIL ENGINEE AND AN C
		OR EMBO BE CONSI
OWNER(S)	DATE	UNAUTHO ALTERATI ADDITION DOCUMEN
APPROVED AS A FINAL SITE PL OF THE PLANNING BOARD OF TH WARWICK ON	HE VILLAGE OF	SEAL OF A PROFESS IS A VIOL SECTION 2 OF THE EDUCATIO
CHAIRMAN	DATE	—
VILLAGE ENGINEER	DATE	

## 5-FT H X 8-FT W EARTH TONE COLOR VINYL SOLID FENCE

N.T.S.

