77 Main Street
Post Office Box 369
Warwick, NY 10990
www.villageofwarwick.org



(845) 986-2031 FAX (845) 986-6884 mayor@villageofwarwick.org clerk@villageofwarwick.org

Village of Warwick Village Board Meeting – August 17, 2020

Pursuant to Governor Cuomo's Executive Order 202.1, Village of Warwick meetings will be conducted virtually through Zoom Videoconference until further notice.

To View the Meeting:

FACEBOOK LIVE - The public may view the meeting live by going to the Village of Warwick's Facebook page: https://www.facebook.com/VillageofWarwick

VILLAGE'S WEBSITE – The public may view the meeting a day or so after its completion by going to the village's website: www.villageofwarwick.org

To Comment - During Privilege of the Floor Only:

FACEBOOK LIVE – Comments may be made during the Village Board Meeting through Facebook Live within privilege of the floor by going to the Village of Warwick's Facebook page: https://www.facebook.com/VillageofWarwick

TELEPHONE – Comments may be made during the Village Board Meeting by calling the Village Clerk's Office within privilege of the floor at (845) 986-2031 ext. 102.

BOARD OF TRUSTEES VILLAGE OF WARWICK August 17, 2020 AGENDA

Call to Order Pledge of Allegiance Roll Call

1.	Introduction by Mayor Newhard.
2.	Acceptance of Minutes: August 3, 2020
	The vote on the foregoing motion was as follows:
	Trustee Cheney Trustee Lindberg Trustee Patterson
	Trustee McManus Mayor Newhard
3.	Acceptance of Reports, July 2020: Clerk's Office & Tax Collection Summary, Justice, Building, Planning Board & ZBA.
	The vote on the foregoing motion was as follows:
	Trustee Cheney Trustee Lindberg Trustee Patterson
	Trustee McManus Mayor Newhard
4.	Authorization to Pay all Approved and Audited Claims # in the amount of \$ in the
	The vote on the foregoing motion was as follows:
	Trustee Cheney Trustee Lindberg Trustee Patterson
	Trustee McManus Mayor Newhard
5.	Police Report - Suspended to Streamline Meeting due to COVID-19

Privilege of the Floor

Please limit your comments to **five** (5) minutes. If reading a document, please submit a copy to the Clerk. Please note all remarks must be addressed to the Board as a body and not to individual Board members. Please state your name clearly before speaking. These rules are taken from the Handbook for Village Officials – New York State Conference of Mayors and Municipal Officials.

Motions

Trustee Cheney's Motions:

	Rudzinski, to attend the NYSBOC 2020 Rescheduled Spring Seminar at a total cost of \$300 on Tuesday, September 22, 2020 – Thursday, September 24, 2020 at the Town of Ramapo Recreation Bubble in Hillburn, NY. Overtime and travel time outside of the regular workday will apply. No mileage reimbursement is applicable, village vehicle will be used.						
	The vote on the foregoing motion was as follows:						
	Trustee Cheney Trustee Lindberg Trustee Patterson						
	Trustee McManus Mayor Newhard						
2.	MOTION to submit to the New York State Department of Transportation the proposed application for a COVID-19 Recovery Temporary Use Permit allowing temporary closure of a portion of Main Street (Route 94) to permit outdoor dining, and upon approval of the application by the DOT, to close the roadway on Thursdays, Fridays, and Saturdays through September 26 th from 4:00 p.m. to 11:00 p.m. pending further extension of Governor Cuomo's Executive Order 202.38 covering those dates.						
	The vote on the foregoing motion was as follows:						
	Trustee Cheney Trustee Lindberg Trustee Patterson						
	Trustee McManus Mayor Newhard						
3.	MOTION to allow temporary closure of a portion of Spring Street to permit outdoor dining on Fridays and Saturdays through September 26 th from 4:00 p.m. to 11:00 p.m. pending further extension of Governor Cuomo's Executive Order 202.38 covering those dates.						
	The vote on the foregoing motion was as follows:						
	Trustee Cheney Trustee Lindberg Trustee Patterson						
	Trustee McManus Mayor Newhard						

1. MOTION to grant permission to Building Inspector/Code Enforcement Officer, Boris

Trustee Lindberg's Motions:

4. **MOTION** to grant permission to the Warwick Valley Rotary Foundation to use the Memorial Park pavilion and surrounding grassy area, the McFarland Drive parking lot, and Railroad Green on Sunday, October 25, 2020 for 'The Great Halloween Hunt'. The

event will take place from 1:00 p.m. to 5:00 p.m., with setup to begin at 11:00 a.m. and breakdown to be completed by 6:00 p.m., pending Governor Cuomo's Executive Orders, NYS Regional Phased Reopening Plan, and NYS Department of Health. Completed park permit, proof of proper insurance, and security deposit have been received. Fit Body Boot Camp to receive notice that the pavilion will be unavailable for their use for afternoon classes on this date.

The vote on the foregoing **motion** was as follows:

	Trustee Cheney Trustee Lindberg Trustee Patterson
	Trustee McManus Mayor Newhard
5.	MOTION to grant permission to Patricia English to use the pavilion and the surrounding grassy area in Memorial Park for outdoor fitness classes from August 18, 2020 through October 31, 2020 with sessions Tuesday through Thursday from 6:15 p.m. to 8:00 p.m. & Saturday and Sunday from 9:15 a.m. to 10:45 a.m. in coordination with Fit Body Boot Camp and November 1, 2020 – November 30, 2020 with sessions Tuesday through Thursday from 5:30 p.m. to 8:00 p.m. & Saturday and Sunday from 8:30 a.m. to 10:45 a.m. pending Governor Cuomo's Executive Orders, NYS Regional Phased Reopening Plan, and NYS Department of Health. Completed park permit, proof of proper insurance, and security deposit have been received.
	The vote on the foregoing motion was as follows:
	Trustee Cheney Trustee Lindberg Trustee Patterson
	Trustee McManus Mayor Newhard

6. RESOLUTION INTRODUCING PROPOSED LOCAL LAW TO AMEND VILLAGE CODE CHAPTER 135 VEHICLES AND TRAFFIC

WHEREAS, the Village Board of the Village of Warwick has before it a proposed local law entitled: "A local law to amend Village Code Chapter 135, 'Vehicles and Traffic' to add traffic safety regulations and traffic control devices."; and

WHEREAS, in order to consider adoption of the proposed local law it is necessary to first introduce it and hold a public hearing upon it;

NOW, THEREFORE, BE IT RESOLVED as follows:

	1.	That the movant of this resolution does hereby introduce the attached				
propose	ed local law;	and				
	2.	That a public hearing on the said local law is hereby set for September 8,				
2020 at	7:30 p.m.; a	nd				
	3.	That the Village Clerk shall publish and post notice of the public hearing.				
		presented the foregoing resolution				
which v	was seconded	by,				
	The	ote on the foregoing resolution was as follows:				
	Barry	Cheney, Trustee, voting				
	Willi	am Lindberg, Trustee, voting				
	Geor	George McManus, Trustee, voting				
	Eilee	Patterson, Trustee, voting				
	Mich	ael Newhard, Mayor, voting				
Trustee	e Patterson'	Motions:				
	Warwick Va 2020 due to 10, 2020 throuse permit, s	grant permission to the Warwick Valley Chamber of Commerce to hold the ley Farmers' Market in the South Street parking lot on Sunday, October 4, he cancellation of Applefest. Permission was previously granted from May bugh November 22, 2020, except for Applefest Sunday. Completed facility ecurity deposit and updated proof of proper insurance have been received as plication that was approved on January 6, 2020.				
	The vote on	he foregoing motion was as follows:				
	Trus	ee Cheney Trustee Lindberg Trustee Patterson				
		Trustee McManus Mayor Newhard				
Tweeto	n MaManus	Motions				

Trustee McManus' Motions:

8. **MOTION** to approve the New York State Gaming Commission form GC-RCF: Raffle Consent Form for Music for Humanity to sell raffle tickets in the Village of Warwick

during the 2020 calendar year and authorize the Village Clerk to sign the same. Approval of form GC-RCF does not authorize the applicant to sell tickets at their leisure. All ticket sales during events and/or street fairs are subject to prior written approval of the event organizers and must be filed in the Clerk's Office. All other ticket sales are subject to prior written approval from the Village Board of Trustees.

The vote on the foregoing motion was as follows:							
Trustee Cheney Trustee Lindberg Trustee Patterson							
Trustee McManus Mayor Newhard							
9. MOTION to acknowledge that Michael Vernieri, Auditor for the Village of Warwick, performed an internal audit of the Village of Warwick Justice Court as of May 31, 2019 to comply with section 2019-a of the Uniform Justice Court Act and has found that all reporting and record keeping is being completed in a timely manner and the reports are in compliance with the New York State requirements.							
The vote on the foregoing motion was as follows:							
Trustee Cheney Trustee Lindberg Trustee Patterson							
Trustee McManus Mayor Newhard							
Reports: Suspended to Streamline Meeting due to COVID-19							
Final Comments from the Floor							
Final Comments from the Board							
Executive Session, if applicable							
Adjournment							

77 Main Street Post Office Box 369 Warwick, New York 10990 www.villageofwarwick.org



(845) 986-2031 FAX (845) 986-6884 mayor@villageofwarwick.org clerk@villageofwarwick.org

FROM THE OFFICE OF THE BUILDING DEPARTMENT

8/12/2020

Honorable Mayor and Trustees,

Due to the Covid pandemic, my annual training conference in Poughkeepsie that was approved and paid for has been cancelled and not rescheduled. They offered to refund or "rollover" the fee for next years Poughkeepsie conference, rollover is what I will opt for.

I was messaged by the other local chapter of NYSBOC(New York State Building Officials Conference) that their July rescheduled conference for Sept 22-24, 2020 in Rockland had additional seats available. I messaged immediately and was put as #1 on the waiting list.

The only other available conference to achieve these combined hours is scheduled for November in Kingston, a further distance to travel.

I wish permission to on short notice be approved to attend this conference should a seat become available. Itinerary has not been disclosed yet.

Attached is the information for the Rockland seminar that was rescheduled for Sept 22-24, 2020. The cost would be \$300 and would likely require some overtime due to scheduling. Itinerary has not been disclosed yet.

I would travel with Mike Moser as he is also registered for this conference so no use of village vehicle or mileage re-imbursement needed.

Thank you for your consideration on such short notice,

Boris Rudzinski

Village of Warwick Building Inspector/Code Official



PO Box 155 Tallman, NY 10982

New York State Building Officials Conference NYSBOC Rockland County Chapter PO Box 155 Tallman, NY 10982



Email - Rocklandnysboc@gmail.com

NYSBOC Rockland Spring Seminar 2020 3 Full Days of Classes Minimum of 19 NYS In-service credit hours*

*(Possibly more)

Dates: Tuesday April 21, 2020 to Thursday, April 23, 2020

<u>Pre-registration is required:</u> Class size is limited. To register complete the information below and return it via mail as soon as possible. If email address is provided, you will receive registration confirmation.

Early Bird Registration - Special Pricing for all three days!

×	×	X	X	×		×	×
	Thr	ee-Day Sem	ninar April 21	, 2020 – A _I	oril 23, 2(020	
Name	MICHAEL M	MOSER	Title		DPW S	SUPERINTENDE	NT
Address	77 MAIN	ST	Phone		845-98	36-2031	
	WARWCK 1	24 10990	Member o	fNYSBOC	YES		
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Please provi	de ID Numbers 🗹	2	E-mail		DPWSUPE	ERUBOREVILLA	SEOFWARWCK.
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-	Registration form ved by Feb. 15, 202		Λ	YSBO	C Roci	kland	
Mail regis	tration form with cl		<u>Early</u>	<u>v Bird</u> S	Specia	l Pricing	
	Rockland County	Chapter					

All Classes \$275.00

After Feb 15th - Regular price of \$300. applies



New York State Building Officials Conference NYSBOC Rockland County Chapter PO Box 155 Tallman, NY 10982 Email – Rocklandnysboc@gmail.com



Vincent Fiorentino President Educational Coordinator Manny Carmona 1st Vice President Ruben Berrios 2nd Vice President Delegate Adam Peltz Treasurer Sergeant at Arms Jane Slavin Secretary Ways & Means Adam Peltz Delegate Ken Dillon Ways & Means

July 2020 President's Report Important Seminar Information

Seminar Information

We believe now that our region has entered phase 4 of reopening, we may be allowed to hold our seminar as it says it will allow educational facilities to open. We believe we fit into that category, but the final word on allowing us to proceed will come from the State of New York. As soon as we hear anything definitive you will be notified by email.

It also appears the State is not going to wave any or all the required in-service hours for 2020. With that said, we are planning to move ahead with having our Seminar on September 22, 23, 24, 2020 with some Important COVID -19 changes/rules.

- 1. We are changing the venue to the Town of Ramapo Recreation Bubble at Torn Valley, 115 Torne Valley Road, Hillburn, NY 10931. This is an exceptionally large space that will allow for social distancing.
- 2. Our class setup will be 8-foot long tables with only 2 participants per table for social distancing.
- 3. Participants MUST have to have their temperature taken daily.
- 4. Participants MUST sign a COVID-19 Liability Waiver daily.
- 5. Participants MUST wear a mask while in the Bubble (of course it can be removed when eating).
- 6. Food we will not be having our typical buffet-style Breakfast and Lunch, there will be wrapped bagels and muffins in the morning and box style lunched daily. The lunch break will be 30 minutes each day.
- 7. The seminar area will be professionally disinfected daily.
- 8. Attendance Scanning Each participant will be responsible for getting scanned at both the start and end of each class. This translates to being in the Bubble at the exact time a class starts and staying to be scanned at the end of the allotted time of the class. This means you must be prepared to be present from 8:00 AM to 5:30 PM on the 8-hour day and 8:00 to 4:30 the 7-hour days.
- 9. If anyone who has registered for the seminar does not feel comfortable with our plan of action and wishes to withdraw please let us know as each person has a different feeling about COVID-19 and safety precautions. Attendees who do not abide strictly to our rules will not be allowed to participate. We are not Policemen, we expect all to follow the stated rules.
- 10. We reserve the right to amend and or add to the rules set fort here.

Vincent Fiorentino Chapter President



Warwick Valley Rotary Foundation PO Box 121 Warwick NY 10990

August 12, 2020

Michael Newhard, Mayor 77 Main Street P.O. Box 369 Warwick, New York 10990

Dear Mayor Newhard and Village of Warwick Trustees,

On behalf of the entire Warwick Valley Rotary Foundation, I would like to formally request the use of the Memorial Park Pavilion and McFarland Drive parking area AND the use of Railroad Green on Sunday, October 25, 2020 to hold a socially distanced family fun event. *The Great Halloween Hunt* will require the knowledge of people, places, and things within the entire Town of Warwick to be able to decipher clues and move closer to solving the puzzle. It's going to be a very exciting event!

There will be two separate "hunts" happening – a walkable hunt in the Village (geared more toward kids) and a driving hunt that will encompass the entire Town, including Greer od Lake and Florida. The Memorial Park Pavilion (driving hunt) and Railroad Green (walking hunt) will serve as regis tion areas and will also serve as a "help desk" for those who are not able to decipher a clue. The people who pre-register (we are encouraging people to pre-register) will receive an email on the morning of the event with a list of clues (the clues will be numbered and each team will start at a different number) – each clue will take the hunters to a local business (that has been previously contacted and is involved in the event). Each business will have a paper with a letter (of the alphabet) of on it. Each team must collect all of the letters from each business and then unscramble the letters to make a word or phrase – and then that team has solved the puzzle. In addition, the hunters have also visited many small businesses throughout the Town and Villages that they may return to later!

I have described the overall concept of *The Great Halloween Hunt* – a socially distant family fun event that will also add some foot traffic to many local businesses. This event is the first of its kind in Warwick and the event will need to comply with the COVID-19 requirements for that day; therefore, the event details may change slightly but the overall concept of the event will remain the same.

The Great Halloween Hunt will start at 12 noon on Sunday, October 25th and end at 5pm. We estimate that we will need the park from 11am to set up through 6pm to cleanup.

If needed, the Warwick Valley Rotary Foundation is an IRS-designated, 501(c)3 Foundation (EIN: 82-2321362).

Please let me know if additional information is needed at (845) 258 - 8305.

Sincerely,

Patricia Lurye-Dempster

Committee Member and Village of Warwick Resident

RECEIVED

AUG 1 2 2020

VILLAGE OF WARWICK VILLAGE CLERKS OFFICE 77 Main Street Post Office Box 369 Warwick, NY 10990 www.villageofwarwick.org



(845) 986-2031 FAX (845) 986-6884 mayor@villageofwarwick.org clerk@villageofwarwick.org

VILLAGE OF WARWICK

INCORPORATED 1867

FACILITY USE REQUEST

Village Park/Facility Requested: Memorial Park Pavilion and Railroad Green *Please use attached map to indicate areas to be used.					
Name of Event (Purpose of Use): The Great Halloween Hunt					
Name of Organization or Individual: Warwick Valley Rotary					
Check one: Non-Profit \(\subseteq 501(c) \) \(\subseteq \) For Profit \(\subseteq \subseteq \) Private Event Proof of Residency: \(\subseteq					
Mailing Address: PO Box 121 Email: warwickvalleyrotary@gmail.com					
Telephone Day: <u>845629649</u> 7 Evening: <u>845629649</u> 7 Cell: <u>845629649</u> 78					
Total Participants Expected: Adults: 50 Children: 50					
Village of Warwick Participants (Number): Non-Resident Participants (Number): How will event be advertised? Social Media Is material or equipment required from the Village of Warwick? □ Yes ☒ No If needed, state type and for what purpose: Is admission fee charged? ☒ Yes □ No If so, what will proceeds be used for? Warwick Valley Rotary Foundation					
Will food be served? □ Yes ⋈ No If yes, please give details:					
The undersigned is over 21 years of age and has read this form and attached regulations and agrees to comply with them. He/she agrees to be responsible to the Village of Warwick for the use and care of the facilities. He/she, on behalf of Warwick Valley Rotary (Name of Organization) does hereby covenant and agree to defend, indemnify and hold harmless the Village of Warwick from and against any and all liability, loss, damages, claims, or actions (including costs and attorneys' fees) for bodily injury and/or property damage, to the extent permissible by law, arising out of or in connection with the actual or proposed use of Village's property, facilities and/or services by Warwick Valley Rotary (Name Organization). Signature of Organization's Representative (Must be a Village of Warwick Resident)					
Address: 32 WOODSIDE DRIVE Telephone: 987 78 23 Clerk Use Only: Security deposit check # 7177 Certificate of Insurance					
Gene Use Inty' Security deposit check # 11 / Certificate of insurance V					

AUG 12 2020


02.07.2020

VILLAGE OF WARWICK VILLAGE CLERKS OFFICE

22. In the event of an accident, please notify the Village Clerk before the end of the next business day.

FACILITY USER does hereby covenant and agree to defend, indemnify and hold harmless the Village of Warwick from and against any and all liability, loss, damages, claims, or actions (including costs and attorneys' fees) for bodily injury and/or property damage, to the extent permissible by law, arising out of or in connection with the actual or proposed use of the Village of Warwick property, facilities and/or services.

I have read the Facilities Use Requirements

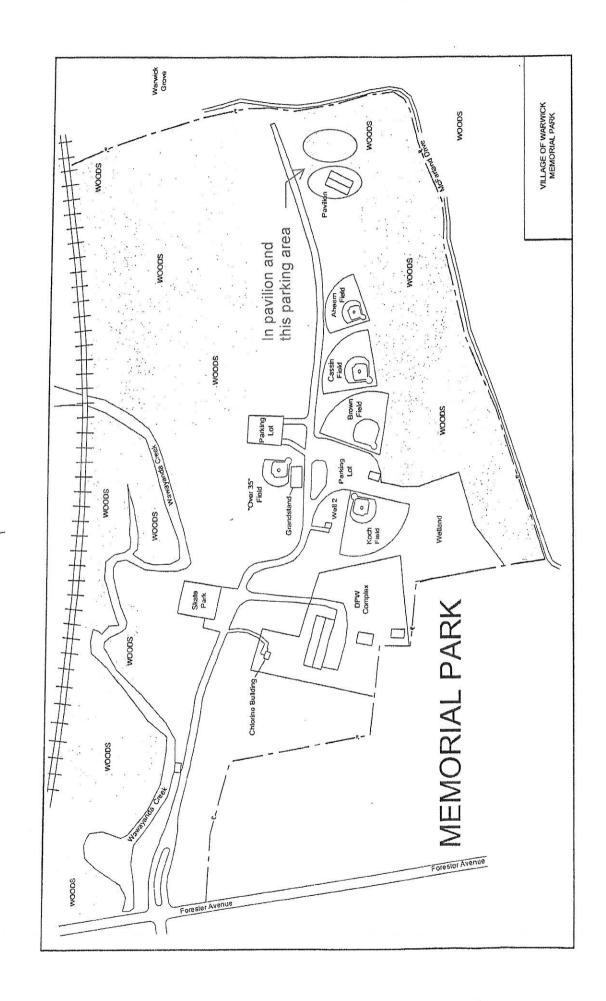

Village of Warwick Board of Trustees 77 Main St. Warwick, NY 10990

To Whom it May Concern,

Please accept this as my request to use the Veterans Memorial Park Pavilion as a fitness training facility. I am a certified personal trainer and group fitness instructor for over 25 years. Due to the COVID closures, all gyms I worked for are closed.

Starting immediately, I would like to be able to use the facility every Tues-Thurs from 6:15-8pm and Saturdays &/or Sundays from 9:15-10:45 am and continue until temperatures permit. (early December).

I understand Fit Body Bootcamp is currently permitted to use the same facility every day from 6-9am and 4-6pm through October. If possible, once that date has passed, if you allow, I'd like to be able to use the facility earlier at 5:30 pm and 8:30 am respectfully.

Thank your for consideration.

Respectfully,

Irish English

RECEIVED

AUG 1 2 2020

VILLAGE OF WARWICK VILLAGE CLERKS OFFICE

77 Main Street
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www.villageofwarwick.org



(845) 986-2031 FAX (845) 986-6884 mayor@villageofwarwick.org clerk@villageofwarwick.org

VILLAGE OF WARWICK

INCORPORATED 1867

Dayly
Today's Date: 8 6 20 Date(s) Requested: 8 17 - 11 30 Time of Event: 9:15 - 11 30 Break Down Time: 10:45 6:15 - 8 pm
Village Park/Facility Requested: Memoral Park Pavilion *Please use attached map to indicate areas to be used. Name of Event (Purpose of Use): Fire SS Training
Name of Organization or Individual: Patricia English (Trish)
Check one: ☐ Non-Profit ☐501(c)3 ☑ For Profit ☐ Private Event Proof of Residency: ☐ Designated Contact: ☐ Sh English
Mailing Address: 32 Weathervane Way Warwick Email: jimmye2@ optonline.ne
Telephone Day: 649-7984 Evening: SAME Cell: SAME
Total Participants Expected: Adults: 5+ (varies) Children:
Village of Warwick Participants (Number): Non-Resident Participants (Number): How will event be advertised? VIO
The undersigned is over 21 years of age and has read this form and attached regulations and agrees to comply with them. He/she agrees to be responsible to the Village of Warwick for the use and care of the facilities. He/she, on behalf of Tathicia Phalish (Name of Organization) does hereby covenant and agree to defend, indemnify and hold harmless the Village of Warwick from and against any and all liability, loss, damages, claims, or actions (including costs and attorneys' fees) for bodily injury and/or property damage, to the extent permissible by law, arising out of or in connection with the actual or proposed use of Village's property, facilities and/or services by Pathicia Phalish (Name Organization). Signature of Organization's Representative (Must be a Village of Warwick Resident) Address: 32 Wathe ware way warwick and Telephone: 345-649-7984 Cierk Use Only: Security deposit check #CASH Certificate of Insurance **Items on file in the Clerk's office.** *Items on file in the Clerk's office.**


22. In the event of an accident, please notify the Village Clerk before the end of the next business day.

FACILITY USER does hereby covenant and agree to defend, indemnify and hold harmless the Village of Warwick from and against any and all liability, loss, damages, claims, or actions (including costs and attorneys' fees) for bodily injury and/or property damage, to the extent permissible by law, arising out of or in connection with the actual or proposed use of the Village of Warwick property, facilities and/or services.

I have read the Facilities Use Requirements

Signature

Date

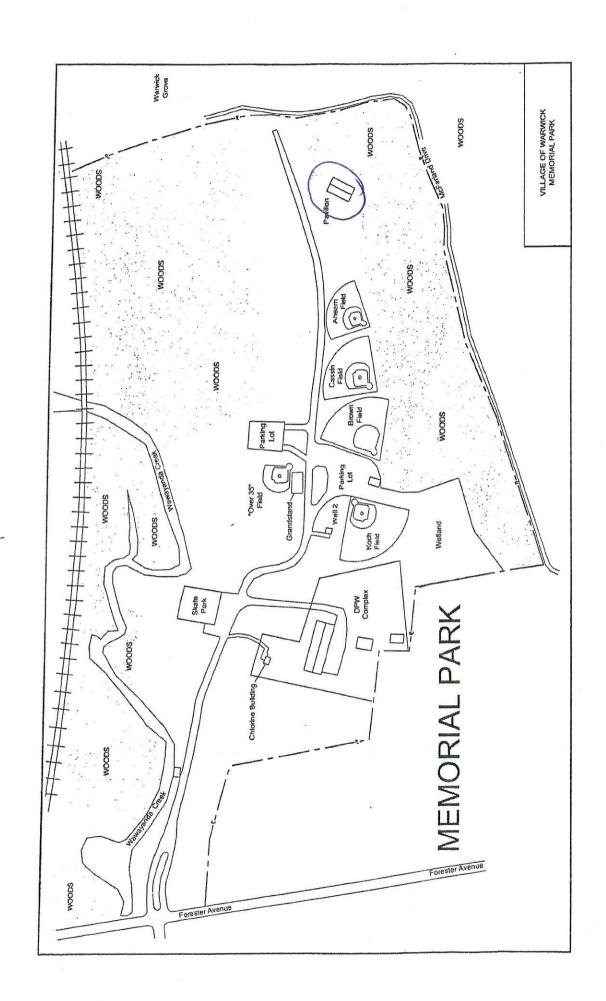

VILLAGE OF WARWICK LOCAL LAW NO. __ OF THE YEAR 2020

A local law to amend Village Code Chapter 135, "Vehicles and Traffic" to add traffic safety regulations and traffic control devices.

Section 1. Purpose:

The purpose of this local law is to promote the public health, safety and welfare by amending Village Code Chapter 135, "Vehicles and Traffic" to add traffic safety regulations and traffic control devices.

Section 2. Amendment Of Village Code:

Village Code Chapter 135, "Vehicles and Traffic", is hereby amended as follows:

(A.) Article II, "Traffic and Pedestrian Control", Section 135-4, "Installation, maintenance and operation of traffic control signals", is hereby amended to include the following except the existing header:

Name of Street	Direction of Travel	At Intersection with
Galloway Road	West	Oakland Avenue
Oakland Avenue	North and South	Galloway Road
Galloway Road	East and West	South Street
South Street	North and South	Galloway Road
Maple Avenue	North and South	Colonial Avenue
Colonial Avenue	West	Maple Avenue

- (B.) Article II, "Traffic and Pedestrian Control", Section 135-5, "One-way roadways designated" is hereby amended as follows:
 - (i.) Delete "Church Street West from Forester Avenue to Main Street" and add in its place "Church Street West from Main Street to Forester Avenue";
 - (ii.) Delete "High Street East from Main Street to Forester Avenue" and add in its place "High Street East from Forester Avenue to Main Street";
 - (iii.) Add the following except the existing header:

Name of Street	Direction of Travel	Limits
Coe Circle	West	Begin and end at Cowdry Street
Mistucky Circle	West	From Cowdry Street to Cornbury Street
Sly Street	South	From Long House to Cropsey Street
Swift Street	North	From Sly Street to Long House Road

- (C.) Article V, "Turning Movements", Section 135-8, "Right turns only permitted at certain locations", is hereby amended as follows:
 - (i.) Delete the following except the existing header:

Name of Street	Direction of Travel	At Intersection of	Time Limits
Wheeler Avenue	North	Main Street	All times

(ii.) Add the following except the existing header:

Name of Street	Direction of Travel	At Intersection of	Time Limits
Wheeler Avenue	South	Main Street	All times
South Street & High Street Intersection	North	Main Street	All times

- (D.) Article VI, "Stop and Yield Intersections", Section 135-11, "Through highways designated: stop and yield signs", is hereby amended as follows:
 - (i.) Delete the following streets and related information except the existing header:

Name of Through	Name of Entrance	Direction From Which Entering	Type of Traffic
Highway	Street		Control Device
Galloway Road	South Street	South	Stop sign

Galloway Road	South Street Extension	North	Stop sign
Main Street	Colonial Avenue	West	Stop sign
Main Street	West Street	East	Stop sign
Oakland Avenue	Galloway Road	West	Stop sign

(ii.) Add the following streets and related information except the header:

Name of Through Highway	Name of Entrance Street	Direction From Which Entering	Type of Traffic Control Device
Park Avenue	Park Way	North	Stop sign
Cornbury Street	Mistucky Circle	West	Stop sign
Cowdry Street	Cornbury Street	South	Stop sign
Cowdry Street	Cornbury Street	North	Stop sign
Cropsey Street	*Clubhouse Street [*FN - Street not named on tax map]	North	Stop sign.
Cropsey Street	Sly Street	South	Stop sign
Hudson Street	*Clubhouse Street [*FN - Street not named on tax map]	South	Stop sign
Hudson Street	Aske Street	South	Stop sign
Hudson Street	Bridge Street	South	Stop sign
Hudson Street	Cropsey Street	South	Stop sign
Long House Road	Swift Street	North	Stop sign
McFarland Drive	Cropsey Street	West	Stop sign
McFarland Drive	Hudson Street	West	Stop sign
McFarland Drive	White Oak Street	West	Stop sign

White Oak	Bridges Street	North	Stop sign
White Oak	Swift Street	North	Stop sign

- (iii.) Under the listing: "Main Street....Grand Union parking lot....West....Stop sign", replace "Grand Union parking lot" with "CVS parking lot".
- (iv.) Replace the listing: "Overlook Drive....Weffing Avenue....North....Stop sign", with "Orchard Street....Welling Avenue....North....Stop sign".
- (E.) Article VI, "Stop and Yield Intersections", Section 135-12, "Stop intersections designated", is hereby amended to add the following except the header:

Stop Sign on	Direction of Travel	At Intersection of
Aske Street	Both	Cropsey Street
Aske Street	North	Long House Road
Bridges Street	Both	Cropsey Street
Coe Street	North	Cowdrey Street
Cowdrey Street	Both	Longhouse Road
Cropsey Street	Both	Aske Street
Cropsey Street	Both	Bridges Street
Cropsey Street	West	Sly Street
Hudson Street	East	Longhouse Road
Long House Road	Both	Hudson Street
Long House Road	South	Cowdrey Street
Long House Road	West	Aske Street
McFarland Road	North	Hudson Street

(F.) Article VIII, "Parking, Standing and Stopping", Section 135-18, "Parking prohibited at all times in certain locations", is hereby amended as follows under the existing header:

		Name of Street	Side	Location
(i.)	Delete:	South Street	Both	From First Street to Railroad Street
(ii.)	Add:	South Street	Both	From First Street to Railroad Avenue

- (G.) Article VIII, "Parking, Standing and Stopping", Section 135-19.1, "Loading and unloading zones established", is hereby repealed and re-enacted to read as follows:
 - "A. The following loading and unloading zones shall be "No Parking-Loading/Unloading Zone, Monday Saturday 6:00 a.m. to 6:00 p.m."

Name of Street	Side	Location
Bank Street	South	From a distance starting at a point 35 feet from the curbline of South Street running a distance of 55 feet.
First Street	North	From a distance starting at a point 76.3 feet from the intersection of South Street on the westerly side and running a distance of 83 feet therefrom
McEwen Street	North	From a point 15 feet westerly from the intersection of Main Street and running a distance of 51 feet west thereof.
Railroad Avenue	South	From a point 133 feet west of the western curbline of South Street to a point 194 feet west thereof

B. The parking, standing or stopping of motor vehicles, except for the loading or unloading of merchandise or other property from a vehicle for no longer than 30 minutes, is prohibited at any of the following locations:

First Street	North	From a point 57 feet east of the intersection of Oakland Avenue to a point 95 feet east of the intersection of Oakland Avenue, with a time limit of 20 minutes
Spring Street	East	From the northern intersection of McEwen Street to a point 64 feet northerly thereof, 24

- (H.) Article VIII, "Parking, Standing and Stopping", Section 135-19.2, "Parking zone for official Village business established", is hereby amended as follow:
 - (i.) Add the following under the existing header:

Name of Street	Side	Location
Main Street		From a point 30 feet southerly from the southerly Wheeler Avenue to a point 70 feet south thereof.

(ii.) Delete the following except the existing header:

Name of Street	Side	Location
Main Street	East	From a point 200 feet southerly from the southerly line of High Street to a point 52 feet south thereof.
Main Street	East	From the center line of West Street to a point 23 feet north thereof.

(I.) Article VIII, "Parking, Standing and Stopping", is hereby amended to add a new Section 135-19.2.1, entitled "Parking reserved for Village personnel only", which shall state as follows:

"Name of Street	Side	Location
Wheeler Avenue	North	From a point 42 feet west of Main Street on the north side for a distance of 56 feet.
Wheeler Avenue	South	From a point 55 feet west of Main Street on the south side for a distance of 60 feet."

- (J.) Article VIII, "Parking, Standing and Stopping", Section 135-19.3, "Parking for handicapped; penalties for offenses", is hereby amended as follow:
 - (i.) In subsection "A", the following entries are deleted except for the existing header:

Name of Street	Side	Location
JPMorgan Parking Lot	Spot No. 15	from a point 45 feet south of South Street and 45 feet northeast of Caboose, also known as Spot No. 15.

McEwen Street	North	Beginning at a point 44 feet from the easterly/curbline of Spring Street to a point 67 feet past thereof with a time limit not to exceed 2 hours.
North Street	North	Beginning at a point 44 feet from the easterly curbline of Spring Street to a point 67 feet east thereof, with a time limit not to exceed 2 hours.
Railroad Avenue	South	from a point 57 feet west of the intersection of South Street to a point 77 feet west of the intersection of South Street.
Second Street	North	from a point 14 feet west of its intersection with South Street to a point 20 feet west thereof.
South Street Parking Lot		Second parking space on north side of parking lot facing Waywayanda Creek and closest to South Street
South Street Parking Lot		First parking space in first row of parking from South Street on south side of lot closest to railroad tracks.
Wheeler Avenue	South	from a point 60 feet west from the westerly curbline of Main Street to a point 22 feet west thereof.
ADA PAR TANK WAS ARREST		

(ii.) In subsection "A", the following entries are added under the existing header:

Name of Street	Side	Location
Chase Parking Lot		From a point 61 feet east of South Street to a point 81 feet

thereof.

North Starting 60 feet from Cottage North Street Street to a point 20 feet north thereof with a time limit not to exceed 2 hours. Railroad Avenue South From a point 75 feet west of the intersection of South Street to a point 95 feet west. Second Street North From a point 14 feet west of its intersection with South Street to a point 34 feet west thereof. South Street Third parking space in the north side of parking lot Parking Lot facing Waywayanda Creek closest to South Street Wheeler Avenue South From a point 35 feet west from the westerly curbline of Main Street to a point 55 west thereof. West From a point 114 feet south Park Avenue of the curbline of Burt Street to a point 162 feet thereof. From a point 202 feet south Park Avenue West of the curbline of Burt Street to a point 238 feet thereof. From a point 48 feet south of East Parkway the curbline of South Street to a point 71 feet south thereof. East From a point 194 feet south Parkway of the curbline of South Street to a point 210 feet south thereof.

(iii.) Subsection "B", is hereby repealed and re-enacted to provide:

- "B. Every person convicted of violating this section shall be subject to a fine of \$100 or by imprisonment of not more than 15 days, or by both such fine and imprisonment."
- (iii.) Subsection "C", is hereby repealed and re-enacted to read as follows:
- "C. Additional regulations at post office and for private property; penalties for offenses.
 - 1. It shall be a violation for any person to stop, stand or park a vehicle in any area designated as a place for handicapped parking in the parking areas of CVS, the United States Post Office or any private property for which site plan approval has been granted by the Village, except for those vehicles used for the transportation of handicapped persons.
 - 2. Every person convicted of violating this subsection shall be subject to a fine of \$100."
- (K.) Article VIII, "Parking, Standing and Stopping", Section 135-19.4, "Stopping prohibited at all times in certain locations", is hereby amended as follow to add the following after the existing header:

Name of Street	Side	Location
Main Street	West	From a point 36 feet south of the curbline of West Street to a point 51 feet thereof.
Main Street	East	From a point 42 feet north of the southern intersection of West Street to a point 51 feet north thereof.

(L.) Article VIII, "Parking, Standing and Stopping", is hereby amended to add a new Section 135-19.5, entitled "Electric Vehicle Charging Station; Electric Vehicles", which shall read as follows:

"135-19.5 Electric Vehicle Charging Station; Electric Vehicles

- A. The following locations are hereby designated as municipal off-street electric vehicle parking spaces at which only the parking of electric vehicles actively engaged in charging shall be permitted:
 - (1) South Street Parking Lot north end: two spaces.

- B. No person shall stop, stand, or park a vehicle other than an electric vehicle within any parking space designated as a municipal off-street electric vehicle parking space. Unless otherwise specifically provided for, any person found guilty of parking, stopping or standing in a vehicle other than an electric vehicle in a municipal off-street electric vehicle parking space shall be fined \$100.
- C. No person shall park an electric vehicle in a parking space designated as a municipal off-street electric vehicle parking space unless such electric vehicle is in the process of charging. Unless otherwise specifically provided for, any person found guilty of parking an electric vehicle in a municipal off-street electric vehicle parking space while not in the process of charging shall be fined \$50.
- D. No person shall park in a space designated as a municipal off-street electric vehicle parking space for more than three continuous hours regardless of whether or not the electric vehicle is the process of charging. Unless otherwise specifically provided for, any person found guilty of parking an electric vehicle in a municipal off-street electric vehicle parking space for more than three continuous hours, whether or not the electric vehicle is the process of charging, shall be fined \$50.
- E. Electric vehicles may be parked in any space designated for public parking, subject to the restrictions that would apply to any other vehicle that would park in that space."
- (M.) Article VIII, "Parking, Standing and Stopping", Section 135-20, "Parking prohibited during certain hours in certain locations", is hereby amended to delete the following except for the existing header:

Name of Street

Side Between the Hours of

Location

Oakland Avenue

West 6:00 p.m. to 11:00 p.m.

25 feet on either side of the center of Oakland Theater

- (N.) Article VIII, "Parking, Standing and Stopping", Section 135-21, "Parking time limited in certain locations", is hereby amended as follows:
 - (i.) Subsection "A" thereof is amended as follows:
 - (a.) In the entry for CVS parking lot upper portion, the "Time Limit" is to be changed from "4 hours" to "4-hour lot limit" with a footnote reading "The Time Limit on parking in the CVS parking lot upper portion shall apply to parking in any space within the upper portion of the lot. Vehicles must exit the upper

portion of the lot after four hours of parking."

- (b.) In the entry for CVS parking lot lower portion, the "Time Limit" is to be changed from "12 hours" to "12-hour lot limit" with a footnote reading "The Time Limit on parking in the CVS parking lot lower portion shall apply to parking on any space within the lower portion of the lot. Vehicles must exit the lower portion of the lot after twelve hours of parking."
- (c.) In the entry for First Street Parking Lot, the "Time Limit" is to be changed from "12-hour parking" to "3-hour metered parking".
- (d.) In the entry for South Street Parking Lot, the "Time Limit" is to be changed from "3 hrs., except Sundays and holidays" to "3-hour lot limit, except Sundays and holidays with a footnote reading "The Time Limit on parking in South Street Parking Lot shall apply to parking on any space within the lot. Except for Sundays and holidays, vehicles must exit the lot after three hours of parking."
- (e.) In the entry for Spring Street Parking Lot, the "Time Limit" is to be changed from "12 hours" to "12-hour lot limit" with a footnote reading "The Time Limit on parking in the Spring Street Parking Lot shall apply to parking on any space within the lot. Vehicles must exit the lot after twelve hours of parking."
- (f.) In the entry for Wheeler Avenue Parking Lot, the "Time Limit" is to be changed from "12 hours" to "12-hour lot limit" with a footnote reading "The Time Limit on parking in the Wheeler Avenue Parking Lot shall apply to parking on any space within the lot. Vehicles must exit the lot after twelve hours of parking."
- (g.) The following entry is to be added below the existing header:

Street	Side	Location	Time Limit
Welling Place	North	From a point 300 feet West of the curbline of Main Street to a point	15 mins.
8		340 feet thereof.	

(h.) The following entries are to be deleted, except for the existing header:

Street	Side	Location	Time Limit
Railroad Avenue	South	Beginning at a point 170 feet east of the easterly curbline of Main Street	15 mins.

to a point 24 feet east thereof.

Spring Street

West From a point 10 feet south 15 mins. of the southerly curbline of McEwen Street to a point

114 feet south thereof.

Welling Place

North From a point 180 feet west 15 mins. of the curbline of Main Street to a point 176 feet west thereof.

- (ii.) Subsection "B" is repealed and re-enacted to read as follows:
 - "(1) Parking shall be allowed in the Chase Parking Lot on South Street under the following terms and conditions:
 - (a) Except as otherwise provided herein, public parking will be available Monday through Sunday, subject to a 4-hour lot limit [FN The Time Limit on parking in the Chase Parking Lot shall apply to parking on any space within the lot. Vehicles must exit the lot after four hours of parking];
 - (b) No public parking will be permitted at any time in the four parking spaces reserved by Chase as designated by signs;
 - (c) Spaces designated "Permit Parking Only" will be available for permit parking on a fee basis, as set forth in section "3" below, Monday through Friday from 5:00 a.m. to 6:00 p.m.;
 - (d) Overnight and weekend parking permits will be available as set forth in section "3" below.
 - (2) Public parking shall be allowed in the First Street Parking Lot, provided that overnight and weekend parking shall be available only for permit parking on a fee basis, as set forth in section "3".
 - (3) Parking permits may be obtained from the Village Clerk during regular working hours upon payment of a yearly fee as set forth in Chapter 63, Fees, to cover the period from January 1 to December 31, and which fee shall be prorated for the unexpired portion of any year. Such annual fee may be amended from time to time upon resolution of the Village Board after public hearing. There shall be an additional annual charge for weekend parking as set forth in Chapter 63, Fees.

- (4) The parking authorized by a parking permit shall be only parking in designated permit-only spaces.
- (5) It shall be unlawful to allow any vehicle to remain parked in the above-mentioned parking lots except during the hours above set forth and for the length of time allowed.
- (6) Violators of the provisions of this Section shall be subject to a fine of \$25 for each offense and their autos shall be towed away and stored at the owner's expense.
- (O.) Article IX, "Parking Meters", Section 135-22, "Parking meter zones established", is hereby amended as follows:
 - (i.) In Subsection "A", the "Parking Time Limit" of all meters shall be listed as "2" hours.
 - (ii.) The following shall be added below the existing header:

Name of Street	Side	Location	Parking Time Limit (hours)	Hours of Meter Operation
Welling Street	North	from a point 180 feet west of Main Street to a point 300 feet thereof.	8:00 a.m. to 6:00 p.n except Sundays and holidays	1. 2

- (iii.) In Subsection "B", the time limit for the First Street Parking Lot shall be changed from 2 hours to 3 hours.
- (P.) Article IX, "Parking Meters", Section 135-23, "Parking meter fees", is hereby repealed and re-enacted to read as follows:
 - "Fees in highway and parking lot parking meter zones. The following parking meter fees are established in parking lot and highway parking meter zones: All parking meter fees are \$0.25 for 60 minutes."
- (Q.) Article IX, "Parking Meters", Section 135-24, "Operation of meter", Subsection "C", is hereby repealed and re-enacted to read as follows:
 - "C. Parking time limits. Any vehicle parking in any designated parking space in a three-hour parking meter zone shall be parked within the lines marked on the street or curb and may occupy said space during the parking limit not to exceed three hours, and any vehicle parking in any designated parking space in a two-hour parking meter zone shall be parked within the lines marked on the street or curb and may occupy said space during the parking limit for a time not to exceed two hours. Failure to deposit the proper fee shall constitute a violation of this

chapter. Upon the expiration of the legal parking time, it shall be the duty of the owner or driver of the vehicle forthwith to remove the vehicle from the parking space, and it shall be unlawful for any person to cause, allow, permit or suffer any such vehicle registered in his name to be parked overtime or remain therein beyond the parking time limit prescribed by this chapter"

- (R.) Article IX, "Parking Meters", Section 135-26, "Deposit of fee", is hereby amended as follows:
 - (i.) Paragraph 4 of Subsection A, "Deposit of fee required", is hereby repealed and re-enacted to read:

"It shall be unlawful and an offense for any person to deposit or cause to be deposited in a parking meter any coins for the purpose of extending the parking time beyond the total lawful parking period not to exceed three hours in a three-hour parking meter zone and two hours in a two-hour parking meter zone."

- (ii). The amount of the fine imposed in Paragraph 2 of Subsection C, "Parking fines", is hereby changed from \$5 to \$10.
- (iii). A new Paragraph 2 shall be added to Subsection C, "Parking fines", which shall read as follows:

"Every person convicted of parking a vehicle in two metered parking spaces (that is, not wholly within a parking meter space as marked and partially within an adjoining metered parking space) shall be punished by a fine of \$25." And existing Paragraphs 2, 3 and 4 of Subsection C, "Parking fines", shall be renumbered as Paragraphs 3,4 and 5 respectively.

(S.) Article XII, "Truck Route and Commercial Bus Route Systems", Section 135-34.1, "Commercial bus route system established", Subsection A, is hereby amended to delete the following entries, except for the existing header:

Name of Street Location

Colonial Avenue From Main Street to the village line

(T.) Article XIV, "Pavement Markings, Section 135-37, "Application of pavement markings authorized", is hereby amended to repealed and re-enacted to read as follows:

"Pavement markings in accordance with the standards and specifications established by the Department of Transportation shall be applied on certain highways or portions of highways, and on all Village park roadways as provided on a list maintained in the office of the Village Clerk, which list may be amended from time to time by resolution of the Village Board; such list shall be deemed incorporated herein by reference."

Section 3. Severability:

If any part or provision of this local law or the application thereof to any person or circumstance be adjudged invalid by any court of competent jurisdiction, such judgment shall be confined in its operation to the part or provision or application directly involved in the controversy in which such judgment shall have been rendered and shall not affect or impair the validity of the remainder of this local law or the application thereof to other persons or circumstances, and the Village Board of the Village of Warwick hereby declares that it would have passed this local law or the remainder thereof had such invalid application or invalid provision been apparent.

Section 4. Effective Date:

This Local Law shall become effective upon filing with the Secretary of State of the State of New York subsequent to having been duly adopted by the Village Board.



WARWICK VALLEY CHAMBER OF COMMERCE INC.

25 SOUTH STREET • WARWICK, NY 10990 PHONE: 845-986-2720 • FAX: 845-986-6982

WEB ADDRESS: www.warwickcc.org • E-mail: info@warwickcc.org

August 11, 2020

The Honorable Michael Newhard Mayor of the Village of Warwick Village Board of Trustees PO Box 369 Warwick, New York 10990

Dear Mayor Newhard and Board of Trustees;

The Warwick Valley Chamber of Commerce would like to formally request permission to hold the Warwick Valley Farmers' Market at the South Street Parking Lot on October 4, 2020 due to the cancelation of Applefest.

I have requested that WRG Sanford Insurance Company send you the required Certificate of Insurance.

We thank you in advance for all your cooperation over the years with Farmers' Market and look forward to seeing you at the Market.

Thank you for your attention to this matter.

Very truly yours,

Michael Johndrow, Executive Director Warwick Valley Chamber of Commerce

Michael a. Johnham

RECEIVED

AUG 11 2020

VILLAGE OF WARWICK
VILLAGE CLERKS OFFICE

Raina Abramson

From:

Charitable Gaming <charitablegaming@gaming.ny.gov>

Sent:

Tuesday, August 11, 2020 9:11 PM

Subject:

RCF - Raffle Consent Form for Music for Humanity

Attachments:

Music For Humanity GC-RCF August 2020.pdf

Good evening;

Please see attached *RCF – Raffle Consent Form* for <u>Music for Humanity</u>. They are requesting authorization to sell raffle tickets within your jurisdiction. Please approve or deny their request on **Part A only**, and send the completed form back to the Commission.

The GC-RCF Municipality Checklist is for Commission use only, and is included to indicate to you that the organization has requested authorization from your municipality.

If you have specific questions regarding the conduct of raffle tickets sales, please contact the organization directly.

Do not hesitate to contact me should you have questions regarding the form.

Regards,

Stacy Harvey
Director, Division of Charitable Gaming
New York State Gaming Commission
1 Broadway Center, Schenectady, NY 12305
(518) 388-0195 | stacy.harvey@gaming.ny.gov |
www.gaming.ny.gov



To:

Municipal Clerk

From:

NYS Gaming Commission; Division of Charitable Gaming

Date:

August 11, 2020

Re:

GC-RCF: Raffle Consent Form

Organization Name:

Music for Humanity

GC 33 306 499 09776 (Identification Number, if required)

Pursuant to the requirements of General Municipal Law Section 189(13) (b), the above referenced authorized organization has requested permission to sell raffle tickets and/or conduct a raffle drawing outside the premises of an authorized organization or an authorized games of chance lessor, within your territorial limits.

Please *approve or deny* the proposed raffle ticket sales and/or raffle drawing and sign the attached **GC-RCF**: **Raffle Consent Form.** Retain a copy for your records and return a copy to the NYS Gaming Commission ("the Commission") within ten (10) days of the date of this notice. Upon receipt by the Commission, completed forms will be sent to the organization.

Failure to return the **GC-RCF**: **Raffle Consent Form** to the Commission within the time allotted will be deemed approval for the organization to conduct the requested raffle ticket sales and/or raffle drawing.

Should you have any questions regarding the conduct of the proposed raffle ticket sales and/or raffle drawing, please contact the organization directly at the number listed on the GC-RCF: Raffle Consent Form.

If you have any additional questions or concerns regarding the GC-RCF: Raffle Consent Form, contact the Division of Charitable Gaming at: charitablegaming@gaming.ny.gov

Mail, fax or email completed form to: NYS Gaming Commission, Division of Charitable Gaming, P.O. Box 7500, Schenectady, NY 12301-7500 · (518) 347-1469 · charitablegaming@gaming.ny.gov





GC-RCF: Raffle Consent Form GC 33-306-499-09776 (Identification Number, if required) Calendar Year: 2020

Instructions: This form must be completed by an authorized organization that intends to sell raffle tickets or conduct a raffle drawing in a municipality other than the city, town or village within which it is domiciled, or intends to hold a raffle drawing on other than its premises, the premise of another authorized organization or municipally owned property. This form must be submitted to the NYS Gaming Commission at least 45 days prior to the start of such raffle ticket sales or raffle drawing and will be submitted to the respective municipalities on the organization's behalf. The form will be returned to the organization by the Commission upon approval or denial by the respective municipalities.

Mall or fax to: NYS Gaming Commission, Charitable Gaming, P.O. Box 7500, Schenectady, NY 12301 (518) 347-1469

Complete Part A if the organization intends to sell raffle tickets in a municipality other than the city, town or village within which it is domiciled. List the names of all the municipalities by the specific City, Town or Village where the organization intends to sell raffle tickets in Column A of the GC-RCF Municipality Checklist.

Complete Part B if the organization intends to conduct a raffle drawing in a municipality other than the city, town or village within which it is domiciled, or if the organization intends to conduct a raffle drawing on other than its premise, the premise of another authorized organization or municipally owned property (even if within your municipality). List the name of the municipality where the organization intends to conduct your drawing in Column A of the GC-RCF Municipality Checklist, if it is a municipality other than the municipality within which the organization is domiciled.

Part A:)	٨	\mathcal{O}	N	
Part A: BARRY	HDELMAN	P	RESIDE	WT.
Name of Organization:	(Print Name of Officer) MUSIC FOR	HUMANITY	(Print Ti	tle)
Street Address: 6	HOWLAND ST	- PO Box	359	
City, Town on Village:	C HESTEL	, Zip Code: 1091	County:	ORANGE.
requests permission to sell Town or Village within w	nich we are domiciled.	(Date) in a municipal		7 1
Signature of Officer	131310/	Email	M/10177.0	Date Date
Contact Name and Title (if	different) Con	tact Email (if different)	845	- 469 - 090U Phone Number
TO BE COMPLETED	BY MUNICIPAL CLE	RK:		
Name of Municipality:				
			(T)	itle)
Approved/Denied by:	/m .			
(Circle one)	(Print Name)	(Signatur	re)	(Date)
Page 1 of 3		www.gaming.ny.gov	GC-RE	CF (Rev. 7/2018)

P610F5

GC-RCF Munici	palit	y Check	list	1 01	ر.								
Name of Organization: MUSIC FOR -	JUM	AN IT	7										
GC 33-306-499-09776 (Identification Number, if required)	GC 33-306-499-09776 Calendar Year: ZO ZO (Identification Number, if required)												
<u>Instructions</u> : Column A of this <i>GC-RCF Municipality Cher</i> Form by an authorized organization that intends to sell raffle the city, town or village within which it is domiciled. You VILLAGE. Complete only Column A.	tickete c	r conduct a m	offic duarries - in		11, 11								
This GC-RCF Municipality Checklist, along with GC-RCF: Commission at least 45 days prior to the start of such raffle will be returned to the organization by the Commission upon	TOVAL CO	ac or wattle		111 / 1									
(A)		(B)	(C)	(D)	(E)								
Name of Municipality (indicate City, Town or Village and County)		Approved	Approved No Response	Denied	Denied No Local Law								
TOWN OF CHESTER ORA	106 E												
" OF WANWICK				***************************************									
VILLAGE OF LeArwick													
TOWN OF MONROE				***************************************									
VILLAGE OF MORROE													
town of warran	ì	14. 1											
CITY OF MIDDLATOWN													
VILLAGE OF GOSHEN													
TOWN OF MONTGORFANT TOWN OF CLAWPOND		*****											
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VILLAGE OF WASHINTONVILLE	4												
NYS GAMING COMMISSION USE ONLY:	J.												
(Print Name) (Title)		•	(Signature)		(Date)								
www.gamin	o.hy.gov		GC-RCF	(Rsv. 7/2018)									

MICHAEL VERNIERI

Certified Public Accountant

9 Oakland Avenue P.O. Box 630 Warwick, NY 10990 (845) 986 - 7636 • (845) 651 - 7636

Michael Vernieri, CPA
Diane Scocozza

255 Greenwich Avenue Goshen, NY 10924 (845) 294 - 6922

Michael Newhard, Mayor Village of Warwick 77 Main Street P.O. Box 369 Warwick, NY 10990

I have examined the books and records of the Village of Warwick – Justice Court as of May 31, 2019 in order to provide an internal audit to comply with section 2019-a of the Uniform Justice Court Act.

The annual audit checklist is enclosed with this report.

I have found that all reporting and record keeping is being completed in a timely manner and the reports are in compliance with New York State requirements. There were no major record keeping deficiencies discovered in this fiscal year.

August 3, 2020

RECEIVED

AUG 1 2 2020

VILLAGE OF WARWICK VILLAGE CLERKS OFFICE

BOARD OF TRUSTEES VILLAGE OF WARWICK August 17, 2020 AGENDA ADDENDUM

MOTION to grant the application of New Cingular Wireless PCS, LLC, ("AT&T") pursuant to Village Code §145-120.1(BB) for renewal of a special use permit for the cellular antenna array on the Saint Anthony's Community Hospital building located at 15 Maple Avenue for a period of five (5) years from July 19, 2020 to July 19, 2025.
The vote on the foregoing motion was as follows:
Trustee Cheney Trustee Lindberg Trustee Patterson
Trustee McManus Mayor Newhard



300 Westage Business Center, Suite 380 Fishkill, New York 12524 T 845 896 2229 F 845 896 3672 cuddyfeder.com

Alec R. Gladd, Esq. agladd@cuddyfeder.com

July 16, 2020

By Email and FedEx

Mayor Michael Newhard And Members of the Village Board of Trustees Village of Warwick 77 Main Street Warwick, New York 10990

Re:

New Cingular Wireless PCS, LLC ("AT&T") – Site OR-003

Renewal of Special Use Permit Application Existing Wireless Telecommunication Facility

Premises:

St. Anthony Community Hospital, 15 Maple Avenue

Warwick, New York

Tax ID #: Section 207, Block 1, Lot 3

Dear Mayor Newhard and Members of the Village Board of Trustees:

This letter and enclosures are respectfully being submitted on behalf of New Cingular Wireless PCS, LLC ("AT&T"), in connection with its application requesting relief from the Special Use Permit renewal requirements or in the alternative to renew the previously issued Special Use Permit in accordance with Section 145-120.1(BB) of the Village Zoning Code.

On July 19, 2010, the Village Board granted AT&T's Special Use Permit application and the Building Department issued Building Permit #2010-0099 on August 12, 2010 thereby permitting AT&T to place a wireless telecommunication facility on the rooftop of the existing St. Anthony Community Hospital building located at 15 Maple Avenue in the Village of Warwick (the "Premises"). Subsequent thereto, the Building Department issued two additional permits #2013-0006 and #2016-0071 on February 1, 2013 and June 7, 2016, respectively, permitting AT&T to make minor modifications to its existing facility. AT&T also applied for and received a Special Use Permit renewal in November 2016 for an additional five-year term, which is set to expire July 19, 2020.¹ Copies of the Village Board Resolution, the 2016 renewal and all three (3) Building Permits and the Certificate of Compliance are annexed hereto as Exhibit A.

¹ It is our understanding based on Village correspondence from 2016 that the 2016 renewal was backdated to July 2015 to account for the expiration of the first 5-year term (originally approved in 2010).



July 16, 2020 Page 2

AT&T respectfully submits that its existing co-located facility conforms with the requirements of Section 145-120.1 of the Village Zoning Code. AT&T has submitted herewith a letter certifying to the best of its knowledge and belief that the facility is in compliance with the existing Special Use Permit as well as the terms and conditions thereof and that a Certificate of Compliance has been issued for the existing facility. See AT&T Certification Letter annexed as Exhibit B. In addition, AT&T's existing facility provides the requisite signal coverage needed to meet AT&T's current coverage requirements in this area of the Village and is necessary to continue providing AT&T's wireless signal coverage to this area of the Village. Indeed, the existing facility allows AT&T to provide service to its customers living in and traveling through this area of the Village of Warwick, thereby complying with its FCC license requirements as well as other FCC rules and regulations governing wireless facilities. As such and given the provisions of Federal Law, AT&T respectfully requests relief from the Special Use Permit renewal requirements in accordance with Section 145-120.1(BB)(2)(f) or in the alternative that it be renewed indefinitely or at minimum a ten (10) year term.

It should also be noted that this Special Permit renewal request is Type II exempt from the State Environmental Quality Review Act ("SEQRA") and no further environmental review is necessary. See 6 NYCRR § 617.5(c)(26).

In support of AT&T's request, please find attached hereto, two (2) copies of the following exhibits:

Exhibit A: Copies of the Ju

Copies of the July 19, 2010 Village Board of Trustees Resolution granting Special Use Permit Approval for the original installation and the November 7 and November 8, 2016 certified motions of the Village Board of Trustees granting a 5 year renewal as well as copies of Building Permit #'s 2010-0099, 2013-0006 and 2016-0071 and the Certificate of Compliance, dated

July 13, 2011;

Exhibit B:

AT&T Compliance Certification Letter, dated July 14, 2020;

Exhibit C:

Exhibit D:

As-Built drawings prepared by Tectonic Engineering & Surveying Consultants, P.C., dated January 26, 2016, consisting of sheets T-1, A-1 through A-6 and G-1 through G-2. Please note no modification to the site has occurred since 2016.

Radio Frequency Safety Survey Report prepared by Waterford Consultants,

LLC, dated February 15, 2016, certifying compliance with the FCC

standards for wireless telecommunication facilities; and



July 16, 2020 Page 3

Exhibit E:

Structural Analysis of Existing Antenna Mounts prepared by Tectonic Engineering & Surveying Consultants, P.C., dated January 12, 2016, certifying that AT&T's existing antenna mounts are adequate to support AT&T's installation.

Please also find enclosed a check made payable to the Village of Warwick in the amount of two thousand five hundred dollars (\$2,500) representing the application renewal fee.

AT&T looks forward to appearing before the Village Board of Trustees at its next available meeting for consideration of this matter. As noted above, and given the provisions of Federal Law, AT&T respectfully requests relief from the Special Use Permit renewal requirements in accordance with Section 145-120.1(BB)(2)(f) or in the alternative that it be renewed indefinitely or at minimum a ten (10) year term. In the interim, should the Village Board or Village Staff have any questions or comments in connection with this application, please do not hesitate to contact me.

Thank you in advance for your consideration of the enclosed.

Very truly yours,

au Gladd

Alec R. Gladd

cc:

Village Building Inspector

AT&T (via email)



PO BOX 77159 St Louis, MO 63177

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000214/000214/000214 002 01 ACYG55 VILLAGE OF WARWICK RECEIVER OF TAXES 132 KINGS HWY WARWICK NY 10990-3115 Check Issued Date:

07/15/2020

Check Number:

3323380977



Pay to: VILLAGE OF WARWICK RECEIVER OF TAXES

Supplier Number:

17594702

APCHK

AT&T Accounts Payable Contacts:

Website: http://paymentstatus.att.com

Telephone: (888) 722-1787 Speak "Accounts Payable"

INV 14JUL20

07/14/2020

\$2,500.00

RENEWAL OF SPECIAL USE PERMIT



TRA1-D-000214/000214 ACYG55 S1-ET-M1-C00001

THE FACE OF THIS CHECK HAS A BLUE-GRAY SECURITY BACKGROUND



50-937/213

JPMorgan Chase Bank, N.A. Syracuse,NY

3323380977

07/15/2020

TWO THOUSAND FIVE HUNDRED AND 00/100

PAY VILLAGE OF WARWICK RECEIVER OF TAXES 132 KINGS HWY

ORDER OF WARWICK NY 10990

\$2,500.00



MP

BY

AUTHORIZED SIGNATURE

VOID IF NOT CASHED WITHIN 180 DAYS

EXHIBIT A

Village of Warwick: AT&T Wireless Communication Facility Special Use Permit Application Findings Statement and Decision

WHEREAS, on March 17, 2010, an application was submitted to the Village of Warwick Village Board of Trustees by New Cingular Wireless PCS, LLC (hereinafter referred to as AT&T) requesting a special use permit to place a Wireless Communications Facility on the rooftop of St. Anthony Community Hospital and

WHEREAS, on June 7, 2010, a public hearing regarding the application was opened by the Village of Warwick Village Board of Trustees. The public hearing was continued on June 21, 2010 and July 6, 2010. On July 6, 2010, the public hearing was closed.

WHEREAS, on July 2, 2010, the Village of Warwick Architectural Review Board reviewed the application for the special use permit; and

WHEREAS, on July 19, 2010 the Village of Warwick Village Board of Trustees appointed themselves as lead agency to complete the SEQRA requirements and has reviewed and completed the long form EAF.

WHEREAS, on July 19, 2010, the Village Board has deemed the application process complete and NOW, THEREFORE the:

The Village of Warwick Village Board of Trustees HEREBY:

FINDS that all of the public comments regarding the application have been received and considered by the Board during the application and hearing process; and further

FINDS that a negative declaration pursuant to SEQRA review shall be issued; and further

FINDS that the findings of the Village of Warwick Architectural Review Board have been reviewed and shall be adopted by the Village Board of Trustees in its entirety and incorporated into these findings; and further

FINDS: that the above referenced application has been reviewed and approved by the Village Engineer and further finds that the application is in full compliance with Section 145-120.1 of the Village of Warwick Zoning law.

Now THEREFORE on this 19th day of July, 2010, and

Upon all the information contained in the Petition of the special use permit, and all of the submissions contained therein, and all of the information obtained during the public hearings, and all of the findings made by this Board and the Lead Agency, The Village of Warwick Village Board of Trustees hereby grants New Cingular Wireless PCS, LLC a Special Use Permit upon a motion made by Bill Iurato and seconded by George McManus with a vote of 5-0 in favor of the issuance of the Special Permit application.



77 Main Street Post Office Box 369 Warwick, New York 10990 www.villageofwarwick.org



(845) 986-2031 FAX (845) 986-6884 mayor@villageofwarwick.org clerk@villageofwarwick.org

A **MOTION** was made by Trustee Patterson, seconded by Trustee Cheney and carried to grant a special use permit to New Cingular Wireless PCS, LLC ("AT&T") for permission to place a cell phone antenna on St. Anthony Community Hospital building located at 15 Maple Avenue in Warwick, NY pursuant to our Local Law 45-120.1(z). Five Ayes.

I, Jo-Ann Rome, Clerk for the Village of Warwick, do hereby certify this to be a true and accurate motion as adopted by the Board of Trustees on November 7, 2016 by unanimous vote and is recorded in the official minute book of the Village of Warwick.

Jo-Ann Rome Village Clerk

SEAL

77 Main Street Post Office Box 369 Warwick, New York 10990 www.villageofwarwick.org



(845) 986-2031 FAX (845) 986-6884 mayor@villageofwarwick.org clerk@villageofwarwick.org

A MOTION was made by Trustee Patterson, seconded by Trustee Cheney and carried to grant a special use permit to New Cingular Wireless PCS, LLC ("AT&T") for permission to place a cell phone antenna on St. Anthony Community Hospital building located at 15 Maple Avenue in Warwick, NY pursuant to our Local Law 45-120.1(z) Five Ayes.

I, BARBARA RANIERI, Deputy Village Clerk of the Village of Warwick, in the County of Orange, State of New York HEREBY CERTIFY that the above motion was made at a regular meeting of the Village Board of the Village of Warwick duly called and held on Monday, NOVEMBER 7, 2016 and has been compared by me with the original minutes as officially recorded in the Village Clerk's Office in the Minute Book of the Village Board and is a true, complete and correct copy thereof and of the whole of said original minutes so far as the same relate to the subject matter.

IN WITNESS WHEREOF, I have hereunto set my hand and affixed the corporate seal of the Village of Warwick this 8th day of November, 2016.

SEAL

Barbara Ranieri, Deputy Village Clerk

Village of Warwick Building Department 77 Main Street Warwick, NY 10990 (845) 986 9888

BUILDING PERMIT

Permit Number: 2010-0099

Permit Date: 8/12/2010

Tax MapNumber: 207-1-3

Permit Fee: \$0.00

A permit is hereby issued by the Building Department of the VILLAGE OF WARWICK, COUNTY OF ORANGE, NEW YORK, for the structure or property described herein:

15 Maple Ave

This permit is issued to:

Contact Type

Other

Contractor

Owner :

Engineer

Name^{*}

at&t

l Conti Communications

St Anthony Hospital

Tectonic Engineering

The filed use for this permit:

Installation of at&t wireless telcommunications antennas on a tower building and associated equipment to include an equiptment shed on the lower roof.

Daniel Kelly

Village of Warwick Code Enforcement Official

Building permits are required to be visibly displayed at the work site and to remain visible until the project has been completed.

A permit under which no work has commenced within one (1) year after the issuance shall expire by limitation, and a new permit must be secured before work can begin. It is the responsibility of the owner and/or contractor to comply with all applicable Village Ordinances and to call for the required inspections at least one day in advance.

Village of Warwick Building Department 77 Main Street Warwick, NY 10990 (845) 986 9888

CERTIFICATE OF COMPLIANCE

Certificate Number: 2010-0099

Address: 15 Maple Ave

Completion Date: 7/13/2011

Section Block Lot: 207-1-3

This certifies that the building or structure located at the premises indicated above, substantially conforms to the approved plans and specifications heretofore filed with this office with application for building permit was issued;

The Occupany/Use for which this certificate is issued to:

Installation of AT&T wireless telcommunications antennas on the tower building and associated equipment to include an equipment shed on the lower roof.

This certificate is issued to: St Anthony Hospital 15-19 Maple Ave Warwick, NY 10990

This certificate is issued by:

Daniel Kelly 1

Village of Warwick Code Enforcement Official

This Certificate of Compliance only attests as to the legal use and occupancy under the Zoning Law and does not certify as to compliance with all of the requirements of the Building Codes of the State of New York effective this date.

Village of Warwick Bullding Department 77 Main Street/PO Box 369 Warwick, NY 10990 (845) 986-2031 Ext 107 villagebuilding@warwick.net

BUILDING PERMIT

Permit Number: 2013-0008

Tax Map Number: 207-1-3

Permit Date: 02/01/2013

Permit Fee: \$75.00

A permit is hereby issued by the Building Department of the VILLAGE OF WARWICK, COUNTY OF ORANGE, NEW YORK, for the structure or property described herein:

15 Maple Ave

This permit is issued to:
St Anthony Hospital
Contractor
Black and Veatch Corp

The filed use for this permit:

Upgrade to the existing wireless communication antennas.
Remove and Replace six antennas, add six remote radio heads, and add a surge suppression box.
New equipment will be painted to match the existing equipment.

Daniel Kelly

Village of Warwick Code Enforcement Official

Building permits are required to be visibly displayed at the work site and to remain visible until the project has been completed.

A permit under which no work has commenced within one (1) year after the issuance shall expire by limitation, and a new permit must be secured before work can begin. It is the responsibility of the owner and/or contractor to comply with all applicable Village Ordinances and to call for the required inspections at least one day in advance.

Village of Warwick Building Department 77 Main Street/PO Box 369 Warwick, NY 10990 (845) 986-2031 Ext 107 building@villageofwarwick.org

BUILDING PERMIT

Permit Number: 2016-0071

Tax Map Number: 207-1-3

Permit Date: 06/07/2016

Permit Fee: \$75.00

A permit is hereby issued by the Building Department of the VILLAGE OF WARWICK, COUNTY OF ORANGE, NEW YORK, for the structure or property described herein:

15 Maple Ave

This permit is issued to:
St Anthony Hospital
Contractor
Black and Veatch Corp

The filed use for this permit: AT&T Antenna modification

Daniel Kelly

Village of Warwick Code Enforcement Official

Building permits are required to be visibly displayed at the work site and to remain visible until the project has been completed.

A permit under which no work has commenced within one (1) year after the issuance shall expire by limitation, and a new permit must be secured before work can begin. It is the responsibility of the owner and/or contractor to comply with all applicable Village Ordinances and to call for the required inspections at least one day in advance.

EXHIBIT B

400 Hamilton Avenue White Plains, NY 10601 T: (516) 702-9195 F: (914) 615-9483

July 14, 2020

Mayor Michael Newhard and Members of the Village Board of Trustees Village of Warwick

Village Hall 77 Main Street Warwick, New York 10990

Re:

New Cingular Wireless PCS, LLC (AT&T) - Site

OR-003 Renewal of Special Use Permit

Existing Wireless Telecommunication Facility

Premises: St. Anthony Community Hospital, 15 Maple Avenue,

Warwick NY Tax ID: Section 207, Block 1, Lot 3

Dear Mayor Newhard and Members of the Village Board of Trustees:

Pursuant to Section 145-120.1(BB)(2) of the Village Zoning Code, New Cingular Wireless PCS, LLC (AT&T), hereby certifies to the best of its knowledge and belief that: 1) it is the holder of the Special Use Permit originally granted on July 19, 2010 in connection with the above referenced matter; 2) its existing wireless telecommunication facility, located at the above-referenced Premises, is in compliance with the previously issued Special Use Permit and conditions set forth therein as well as all applicable statutes, laws, rules and regulations; and 3) the existing facility has not been moved, relocated, rebuilt or otherwise modified since the issuance of the original Special Use Permit other than the minor amendments granted under Building Permit # 2013-0006 dated February 1, 2013 and Building Permit #2016-0071 dated June 7, 2016.

Accordingly, AT&T respectfully requests its Special Use Permit for its existing Wireless Telecommunication Facility at the Premises be renewed indefinitely considering the provisions of Federal Law or in the alternative for a new ten (10) year term.

Sincerely,

Joseph C. Dillo

EXHIBIT C

ENGINEERING

2010 BUILDING CODE OF NEW YORK STATE
NPPA 70 - NATIONAL ELECTRIC CODE
2010 FIRE CODE OF NEW YORK STATE
2010 ENERGY CONSERVATION CONSTRUCTION CODE OF NEW YORK STATE

GENERAL NOTES

THE FACILITY IS UNMANNED AND NOT FOR HUMAN HABITATION. A TECHNICIAN WILL VISIT THE SITE AS REQUIRED FOR ROUTINE MAINTENANCE. THE PROJECT WILL NOT RESULT IN ANY SIGNIFICANT DISTURBANCE OR EFFECT ON DRAINAGE; NO SANITARY SEWER SERVICE, POTABLE WATER, OR TRASH DISPOSAL IS REQUIRED AND NO COMMERCIAL SIGNINGE IS PROPOSED.

PROJECT DESCRIPTION

UPGRADE OF EXISTING TELECOMMUNICATIONS FACILITY, INCLUDING INSTALLATION OF (3) REPLACEMENT ANTENNAS, (3) NEW RADIO HEAD UNITS, AND ASSOCIATED APPURTENANCES ON AN EXISTING ROOFFOP, (ADD 4 WAY RX 2C RRH, SWAP LTE ANTENNA)

SITE INFORMATION

PROPERTY OWNER: ADDRESS:

ST. ANTHONY COMM. HOSPITAL

ST. ANTHONNY COMMUNITY HOSPITAL

FROM

15-19 MAPLE AVENUE WARWICK, NY 10990

PROPERTY OWNER:

BERNARD BERGER

SITE CONTACT:

COUNTY:

(845) 363-5928 ORANGE

LATITUDE (NAD 83):

41,26135 -74,3576

LONGITUDE (NAD B3):

ZONING JURISDICTION: VILLAGE OF WARWICK

ZONING DISTRICT:

CONTINUING CARE RETIREMENT COMMUNITY 207-1-5

PARCEL #:

OCCUPANCY GROUP:

POWER COMPANY:

TELECOMMUNICATION FACILITY DRANGE AND ROCKLAND

TELEPHONE COMPANY:

VERIZON (800) 843-2255

SITE ACQUISITION MANAGER: BLACK & VEATCH CONNIE GORGA

(913) 458-9078

NE CONTACT:

TECTONIC GREG LAHEY (845) 567-6656

ENGINEERING MANAGER:

BLACK & VEATCH PATRICK CONNELL (913) 458-1881

CONSTRUCTION MANAGER:

BLACK & VEATCH ALDRIC GOMEZ (913) 458-1806

RF ENGINEER:

BLACK & VEATCH GENE CHANG (913) 458-1812

RF DATA SHEET NOTE

CONTRACTOR SHALL OBTAIN LATEST RF DATA SHEET AND CONFIRM SAME WITH BLACK AND VEATCH CONSTRUCTION MANAGER PRIOR TO START OF CONSTRUCTION.

CONTACT INFORMATION

ENGINEER:

TECTONIC ENGINEERING & SURVEYING CONSULTANTS P.C. 1279 ROUTE 300 NEWBURGH, NY 12550

CONTACT: MIKE PA


PHONE:

(845) 567-8656 (EXT. 2808)

SITE NAME: WARWICK CENTRAL NATIONAL SITE ID: NYCWNY4003 CASPR #: 2191A01AIJ, PACE #: MRNYC020071



LTE #: NML03003, FA#:10133512, SITE#:OR-003 LTE AC-ROOFTOP

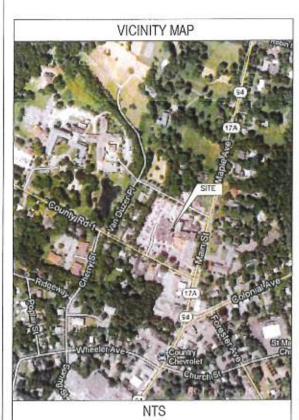



DRIVING DIRECTIONS

HEAD SOUTH, SLIGHT RIGHT ONTO AT&T WAY, CONTINUE STRAIGHT TO STAY ON AT&T WAY, MERGE ONTO US-202 S/US-208 S. TURN LEFT ONTO SCHIEF MOUNTAIN RD. USE THE LEFT LANE TO TAKE THE INTERSTATE 287 N. RAMP, MERGE ONTO 1-287 N. TAKE EXIT 528 TO MERGE ONTO NJ-23 N. TOWARD BUTLER, MERGE ONTO NJ-23 N. CONTINUE STRAIGHT TO STAY ON NJ-23 N. KEEP RIGHT TO CONTINUE ON GERMANIOWN RD. TURN LEFT ONTO WACOPIN RD. SLIGHT RIGHT ONTO UNION VALLEY RD. TURN LEFT TO STAY ON UNION VALLEY RD. CONTINUE STRAIGHT ON WHITE RD. SLIGHT LEFT ONTO WARWICK TURNPIKE, ENTERING NEW YORK, TURN RIGHT ONTO MY-94 E. DESTINATION WILL BE ON THE LEFT.

INCLUDED ITEMS IN SCOPE

PER SECTION 5 OF THE PROFESSIONAL SERVICES AGREEMENT 78.0118 BETWEEN OVERLAND CONTRACTING INC. (OCI) AND TECTONIC (REVISION 1), TECTONIC IS PROVIDING THIS DRAWING PACKAGE AS A COMPLETE DELIVERABLE FOR THE SCOPE AWARDED, ONLY SUCH INFORMATION THAT IS PROVIDED TO AND REQUIRED OF TECTONIC IS INCLUDED. ANY AND ALL OTHER INFORMATION THAT MAY BE REQUIRED BY THE MUNICIPALITY FOR ANY ZONING/PLANNING APPLICATION TO BE DEEMED COMPLETE IS TO BE COORDINATED AND PROVIDED BY OTHERS.

	DRAWING INDE	EX
SHEET NO:	SHEET TITLE	
T-1	TITLE SHEET	
A-1	SITE PLAN	
A-2	EQUIPMENT PLAN	
A-3	ELEVATION & MOUNTING DETAILS	
A-4	ANTENNA PLANS & SCHEDULE	
A-5	PLUMBING DIAGRAMS	
A-6	NOTES	
G-1	GROUNDING PLAN & NOTES	10001
G-2	GROUNDING DETAILS & ELECTRICA	L NOTES
	AS-BUILT REDI	INE
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Field Coordinator		Date
	eer Shall Review Redline Drawings T The Original Design Intent And/Or A	
Market Lead Engi	neer	Belic
	DO NOT SCALE DRA	WINGS

THESE DRAWINGS ARE FORMATTED FOR 24"X36". OTHER SIZED VERSIONS ARE NOT PRINTED TO THE SCALE SHOWN, CONTRACTOR SHALL VERIFY ALL PLANS & EXISTING DIMENSIONS & CONDITIONS ON THE JOB SITE & SHALL IMMEDIATELY NOTIFY THE ENGINEER IN WRITING OF ANY DISCREPANCIES BEFORE PROCEEDING WITH THE WORK OR BE RESPONSIBLE FOR SAME.



[] Dig With Care

THIS SET OF DRAWINGS SHALL NOT BE USED FOR CONSTRUCTION PURPOSES UNTIL THE DRAWINGS HAVE DEEN MARKED "ISSUED FOR CONSTRUCTION" BY TECTIONIC.

LTE 2C

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NEW CINGULAR WIRELESS PCS, LLC ONE AT&T WAY BEDWINSTER, NJ 07921



BLACK & VEATCH

BLACK & VEATCH CORPORATION 650 FROM RD, SUITE 575, PARAMUS, NJ 07652

UNDER CONTRACT WITH OVERLAND CONTRACTING INC

TECTONIC

- PLANNING
 ENGINEER
- SURVEYING
- CONSTRUCTION MANAGEM
- TESTONE Engineering & Narveying Con 1278 MOUTE JOU
- Phone: (845) 567-6858 Fax: (848) 567-6703 year-lesterlesrepheering.a-

PROJECT NO: 8002.NYCWNY4003

DRAWN BY: MP

CHECKED BY: GL

01/29/16 ISSUED FOR FERMIT
REV DATE DESCRIPTION




COPIES OF THIS COCUMENT WITHOUT AN ORIGINAL SIGNATURE AND AN ORIGINAL EMBOSSED SEAL OF THE PROFESSIONAL ENGINEER OR LAND SURVEYOR SHALL NOT BE CONSIDERED VALID COPIES.

SITE NAME: WARWICK CENTRAL SITE NO. NYCWNY4003 ADDR: 15 MAPLE AVENUE WARWICK, NY 10990


SHEET TITLE
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T-1



NORTH NOTE:
NORTH SHOWN HAS BEEN ESTABLISHED USING
THE USOS QUADRANGLE 7.5 MINUTE MAPS AND
IS APPROXIMATE. VERIFY TRUE NORTH PRIOR
TO INSTALLATION OF ANTENNAS.

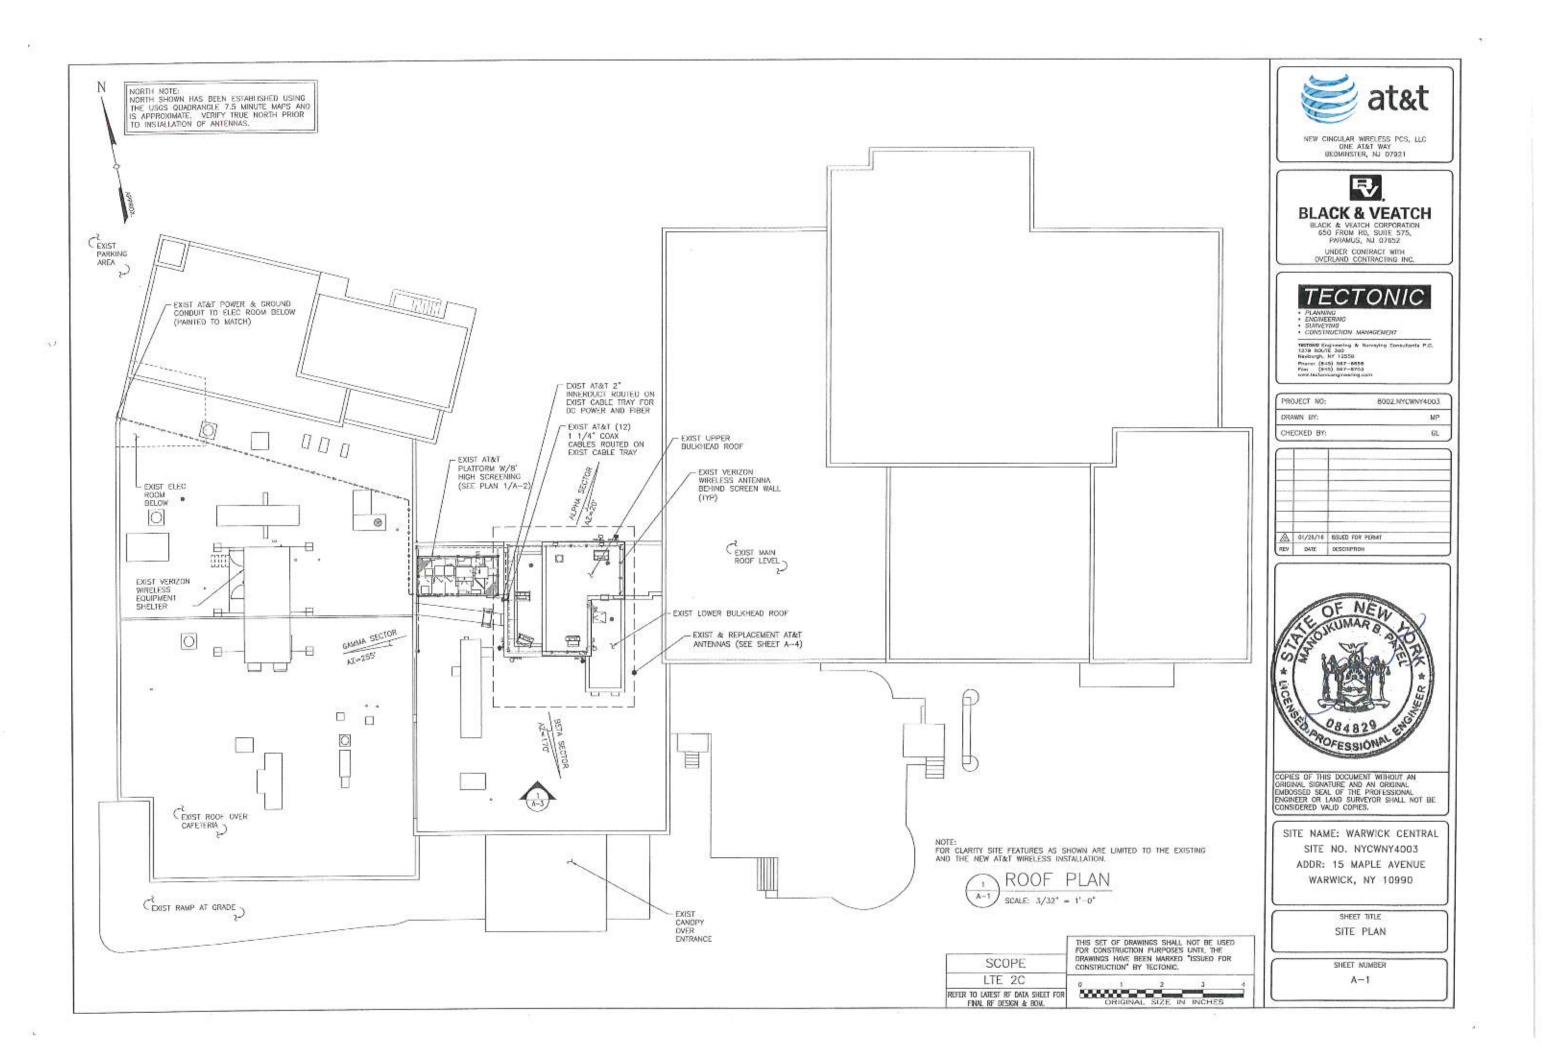

NOTE: NO WORK IS PROPOSED ON THE EQUIPMENT PLATFORM UNDER THIS SCOPE.

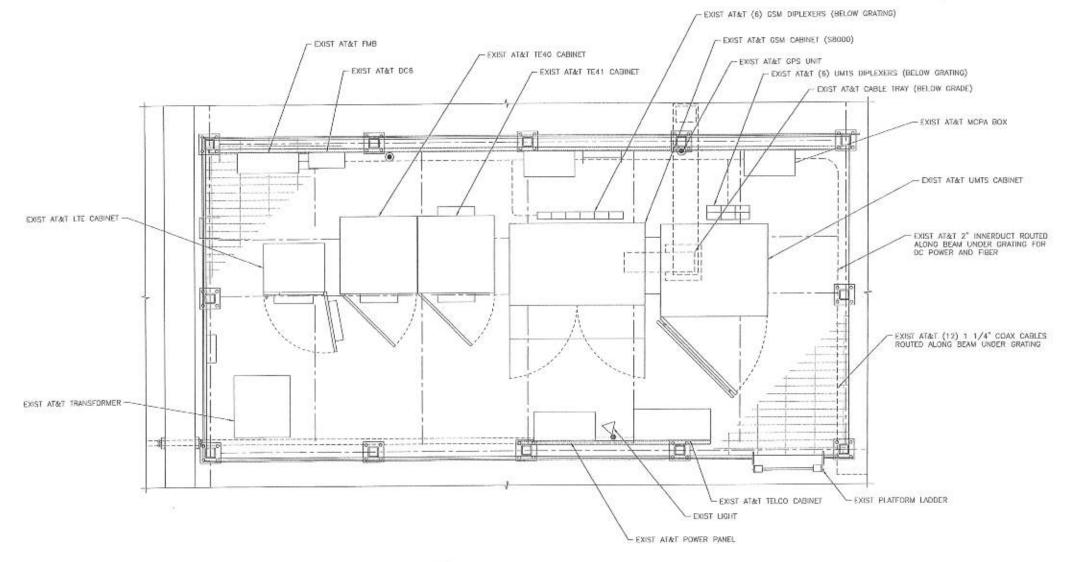

SCOPE LTE 2C

REFER TO LATEST RF DATA SHEET FOR FINAL RF DESIGN & BOW. ORIGINAL SIZE IN INCHES

CONSTRUCTION" BY TECTONIC.

THIS SET OF DRAWINGS SHALL NOT BE USED FOR CONSTRUCTION PURPOSES UNTIL THE DRAWINGS HAVE BEEN MARKED "ISSUED FOR



NEW CINGULAR WIRELESS PCS, ELC ONE AT&T WAY BEDMINSTER, NJ 07921



BLACK & VEATCH

UNDER CONTRACT WITH OVERLAND CONTRACTING INC.

TECTONIC

PROJECT NO

Phones (845) 567-5656 Fas: (845) 567-5703 www.tastonicongineering or

8002 NYCWNY4003

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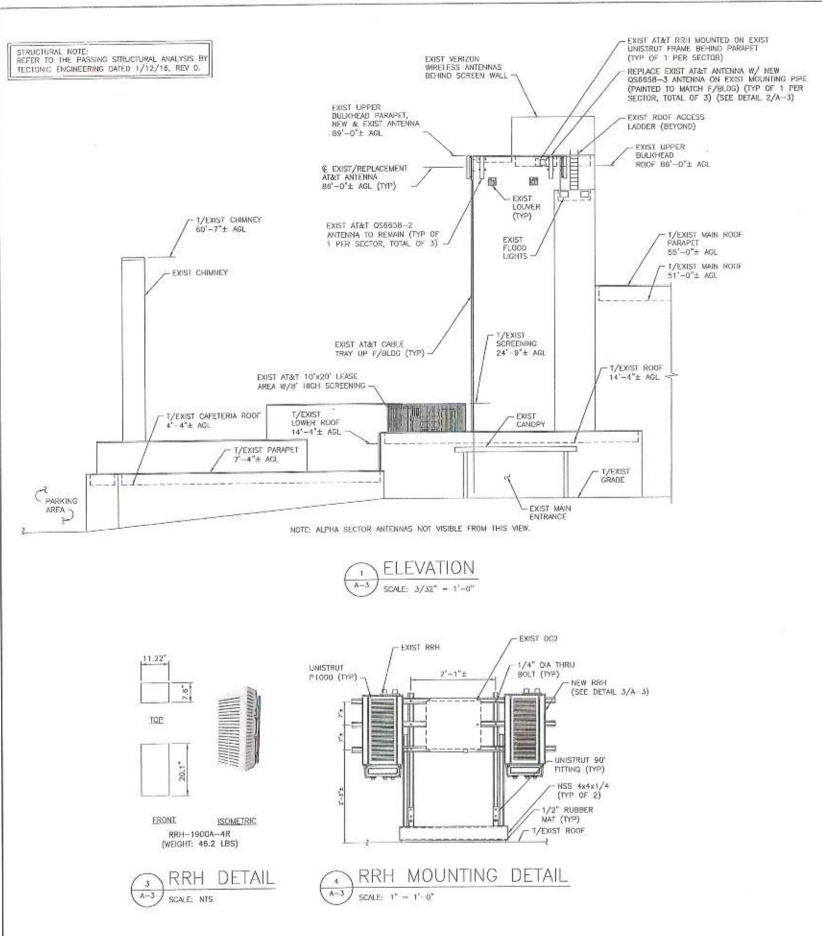
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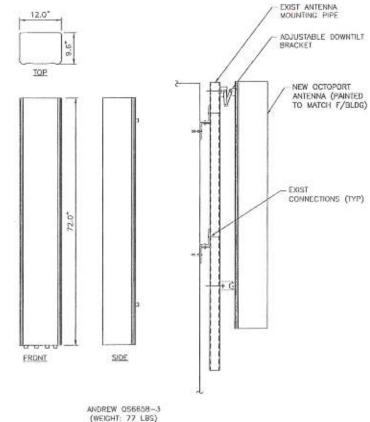
SITE NAME: WARWICK CENTRAL SITE NO. NYCWNY4003 ADDR: 15 MAPLE AVENUE WARWICK, NY 10990

> SHEET TITLE EQUIPMENT PLAN

> > SHEET NUMBER

A-2





ANTENNA DETAIL

SCALE: 1" = 1'-0"

SCOPE

LTE 2C

REFER TO LATEST RF DATA SHEET FOR



NEW CINGULAR WIRELESS PCS, LLC ONE AT&T WAY BEDMINSTER, NJ 07921



BLACK & VEATCH

BLACK & VEATCH CORPORATION 650 FROM RD, SUITE 575, PARAMUS, NJ D7652

UNDER CONTRACT WITH OVERLAND CONTRACTING INC

TECTONIC

- SURVEYING CONSTRUCTION MANAGEMENT

HISTORIC Engineering & Surveying Consultants P.C. 1279 FOURT 200 Revisings, NY 12850 Phones (R4S) 587-6830 Four (R4S) 587-6873 www.katchiconglosering.com

PROJECT, NO: 8002.NYCWNY4003 DRAWN BY: MP CHECKED BY: CL. ⚠ 01/26/18 ISSUED FOR PERSON MEN DATE DESCRIPTION



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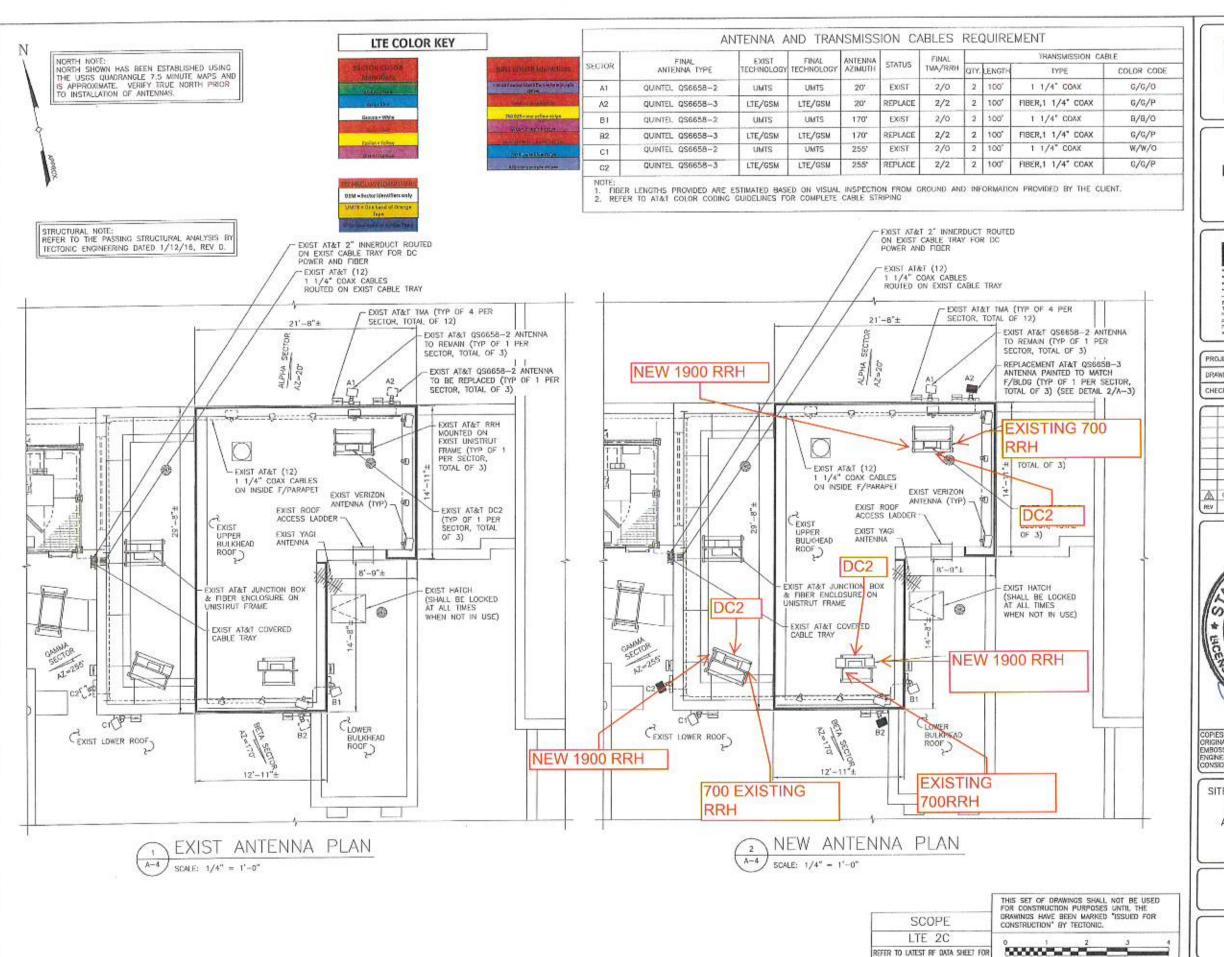
SITE NAME: WARWICK CENTRAL SITE NO. NYCWNY4003 ADDR: 15 MAPLE AVENUE WARWICK, NY 10990

> SHEET TITLE ELEVATION & MOUNTING DETAIL

> > SHEET NUMBER A-3

0 1 ARIGINAL SIZE IN

THIS SET OF DRAWINGS SHALL NOT BE USED FOR CONSTRUCTION PURPOSES UNTIL THE DRAWINGS HAVE BEEN MARKED "ISSUED FOR CONSTRUCTION" BY TECTONIC.





NEW CINGULAR WIRELESS PCS, LLC ONE AT&T WAY BEDMINSTER, NJ 07921



BLACK & VEATCH

BLACK & VEATCH CORPORATION 650 FROM RO, SUITE 575, PARAMUS, NJ 07652

UNDER CONTRACT WITH OVERLAND CONTRACTING INC

TECTONIC

- PEANNING
- SURVEYING
- SURVETING
 CONSTRUCTION MANAGEMI

RESTAND Engineering & Burveying Consultants P.C. 1279 Hours, 300 Newhorph, NY 13550

Newburgh, NY 12550 Phone: (845) 567-5656 Fax: (845) 567-5793 www.tactonleamy/neering.ex

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CHECKED BY: GL

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REV DATE DESCRIPTION




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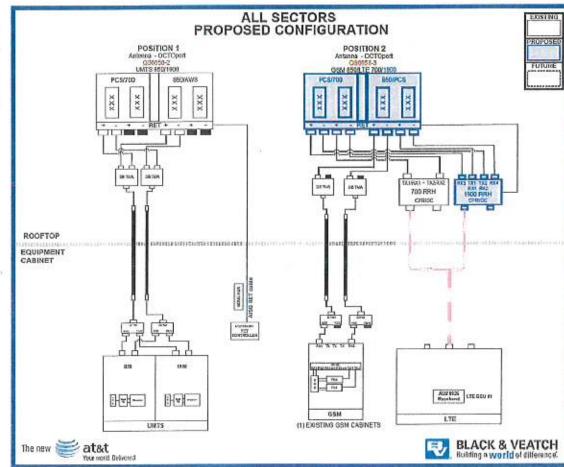
> SHEET TITLE ANTENNA PLANS & SCHEDULE

> > SHEET NUMBER

A-4



SCALE: N.T.S.

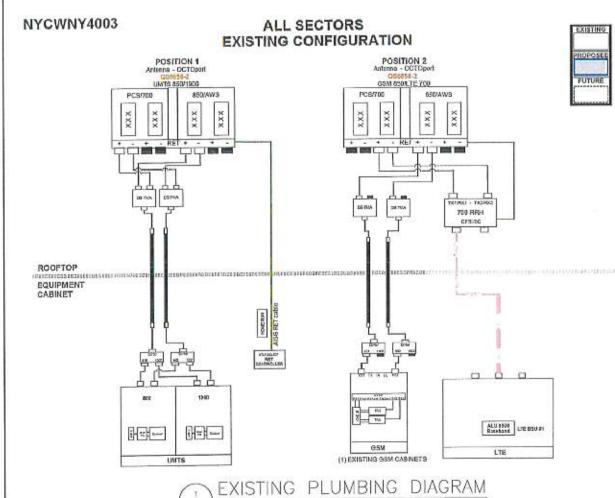

PROPOSED PLUMBING DIAGRAM SCALE: N.T.S.



NEW CINGULAR WIRELESS PCS, LLC ONE AT&T WAY BEDWINSTER, NJ 07921



BLACK & VEATCH

UNDER CONTRACT WITH OVERLAND CONTRACTING INC.

TECTONIC

PLANNING
 ENGINEERING
 SURVEYING
 CONSTRUCTION MANAGEMENT

TEUTONNE Engineering & Surveying Consultants P.C. 1279 ROUTE 300 Nordearch, NY 12890 Phanes (848) 507–5050 Fax: (848) 507–5070 sww.lackorreprineering.com

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SITE NAME: WARWICK CENTRAL SITE NO. NYCWNY4003 ADDR: 15 MAPLE AVENUE WARWICK, NY 10990

> SHEET TITLE PLUMBING DIAGRAMS

> > SHEET NUMBER

A-5

THIS SET OF DRAWINGS SHALL NOT BE USED FOR CONSTRUCTION PURPOSES UNTIL THE DRAWINGS HAVE BEEN MARKED "ISSUED FOR CONSTRUCTION" BY TECTOMIC. SCOPE LTE 2C ORIGINAL SIZE IN INCHES REFER TO LATEST RF DATA SHEET FOR FINAL RF DESIGN & BOW.

GENERAL CONSTRUCTION NOTES

- ALL WORK SHALL CONFORM TO THE REQUIREMENTS OF THE NEW YORK STATE BUILDING CODE, LATEST VERSION AND ALL OTHER APPLICABLE CODES AND ORDINANCES.
- EXISTING BUILDING INFORMATION WAS DETAINED BASED ON A UNITED SITE
- EXISTING BUILDING INFORMATION AS CONTINUED BASED ON A DISTRIBUTION BY TECTONIC ENGINEERING.

 OCCUPANCY IS LIMITED TO PERIODIC MAINTENANCE AND INSPECTION, APPROXIMATELY 2 TIMES PER MONTH, BY ATAT TECHNICIANS.

 NO NOISE, SMOKE, DUST OR DOOR WILL RESULT FROW THIS PROPOSAL OUTDOOR STORAGE AND SOLID WASTE CONTAINERS ARE NOT PROPOSED.

 ALL MATERIALS SHALL BE FURNISHED AND WORK SHALL BE PERFORMED IN
- ALL MATERIALS SHALL BE FORMSHID AND WORK SHALL BE PERFORMED IN
 ACCORDANCE WITH THE PROJECT SPECIFICATIONS.
 SUBCONTRACTOR SHALL BE RESPONSIBLE FOR OBTAINING ALL PERMITS AND
 INSPECTIONS REQUIRED FOR CONSTRUCTION.
 SUBCONTRACTOR SHALL BE RESPONSIBLE FOR REPAIRING ANY DAMAGE
 CAUSED BY THE CONSTRUCTION OPERATION.
 SUBCONTRACTOR SHALL REMOVE ALL TRASH AND DEBRS FROM THE SITE ON

- A DAILY BASIS.

 10. INFORMATION SHOWN ON THESE DRAWINGS IS BASED ON A LIMITED SITE INSPECTION. SUBCONTRACTOR SHALL NOTIFY BLACK & VEATCH OF ANY CREPANCIES PRIOR TO DRDERING MATERIALS OR PROCEEDING WITH

ANTENNA NOTES

- DESIGN AND CONSTRUCTION OF ANTENNA SUPPORTS SHALL ALSO CONFORM TO ANSI/TIA-222-G-2005 "STRUCTURAL STANDARD FOR ANTENNA SUPPORTING STRUCTURES AND ANTENNAS"
- 2. ALL ANTENNA MOUNTS AND ASSOCIATED APPURTENANCES SHALL BE INSTALLED WITH DOUBLE NUTS AND SHALL BE INSTALLED IN ACCORDANCE WITH MANUFACTURER'S SPECIFICATIONS.
 ALL CABLES SHALL BE GROUNDED WITH COAXIAL CABLE GROUNDING KITS.
- FOLLOW THE MANUFACTURER'S RECOMMENDATIONS. GROUNDING AT THE ANTENNA LEVEL.
- GROUNDING AT MID LEVEL, TOWERS WHICH ARE OVER 200'-0", ADDITIONAL CABLE GROUNDING REQUIRED.
- GROUNDING AT BASE OF TOWER PRIDE TO TURNING HORIZONTAL. GROUNDING OUTSIDE THE EQUIPMENT SHELTER AT ENTRY PORT.
 GROUNDING INSIDE THE EQUIPMENT SHELTER AT THE ENTRY PORT.
- ALL PROPOSED GROUNDING BAR DOWNLEADS ARE TO BE TERMINATED TO THE EXISTING ADJACENT GROUNDING BAR DOWNLEADS A MINIMUM DISTANCE OF 4'-0" BELOW GROUNDING BAR, TERMINATIONS MAY BE EXOTHERMIC OR
- THE CONTRACTOR SHALL BE RESPONSIBLE FOR VERIFYING THE ANTENNA AND THE COAX CONFIGURATION IS THE CORRECT MAKE AND MODELS DOING TO INSTALLATION.
- 6. ALL CONNECTIONS FOR HANGERS, SUPPORTS, BRACING, ETC. SHALL BE INSTALLED PER TOWER MANUFACTURER'S SPECIFICATION & RECOMMENDATIONS.
 CONTRACTOR SHALL REFERENCE THE TOWER STRUCTURAL ANALYSIS/DESIGN
- DRAWINGS FOR DIRECTIONS ON CABLE DISTRIBUTION/ROUTING.
 IT IS THE CONTRACTORS RESPONSIBILITY TO VERIFY ANTENNA, TMAS,
 DIPLEXERS, AND COAX CONFIGURATION, MAKE AND MODELS PRIOR TO INSTALLATION.
- ALL CONNECTIONS FOR HANGERS, SUPPORTS, BRACING, ETC. SHALL BE INSTALLED PER TOWER MANUFACTURER'S RECOMMENDATIONS.
- 10. CONTRACTOR SHALL REFERENCE THE TOWER STRUCTURAL ANALYSIS/DESIGN DRAWINGS FOR DIRECTIONS ON CABLE DISTRIBUTION/ROUTING.
- DRAWINGS FOR DIRECTIONS ON CABLE DISTRIBUTION, VOLUME,
 11, ALL OUTDOOR RE CONNECTORS/CONNECTIONS SHALL BE WEATHERPROOFED,
 EXCEPT THE RET CONNECTORS, USING BUTYL TAPE AFTER INSTALLATION AND
 FINAL CONNECTIONS ARE MADE, BUTYL TAPE SHALL HAVE A MINIMUM OF
 ONE-HALF TAPE WIDTH OVERLAP ON EACH TURN AND EACH LAYER SHALL BE
 WRAPPED THREE TIMES, WEATHERPROOFING SHALL BE SMOOTH WITHOUT BUCKLING, BUTYL BLEEDING IS NOT ALLOWED.

 12. IF REQUIRED TO PAINT ANTENNAS AND/OR COAX:
- TEMPERATURE SHALL BE ABOVE 50' F
- PAINT COLOR MUST BE APPROVED BY BUILDING OWNER/LANDLORD.
- FOR REGULATED TOWERS, FAA/FOC APPROVED PAINT IS REQUIRED. DO NOT PAINT OVER COLOR CODING OR ON EQUIPMENT MODEL.

STRUCTURAL STEEL NOTES

- DESIGN AND CONSTRUCTION OF STRUCTURAL STEEL SHALL CONFORM TO THE AMERICAN INSTITUTE OF STEEL CONSTRUCTION "SPECIFICATION FOR STRUCTURAL STEEL BUILDINGS, ALLOWABLE STRESS DESIGN AND PLASTIC
- STRUCTURAL STEEL WIDE FLANGE SHAPES SHALL CONFORM TO ASTM A992, "STEEL FOR STRUCTURAL SHAPES FOR USE IN BUILDING FRAMING", CRADE 50, UNLESS OTHERWISE INDICATED. IF THE MEMBER SIZES INDICATED ARE NOT AVAILABLE IN THIS GRADE, ASTM A572 "HIGH-STRENGTH LOW-ALLOY COLUMBIUM-VANADIUM STRUCTURAL STEEL", GRADE 50, MAY BE
- HOLLOW STRUCTURAL SECTIONS (HSS) SHALL CONFORM TO ASTM A500. "COLD-FORMED WELDED & SEAWLESS CARBON STEEL STRUCTURAL TUBING IN ROUNDS AND SHAPES", GRADE B.
- MISCELLANEOUS STEEL, INCLUDING CHANNELS, ANGLES, PLATES, AND BARS SHALL CONFORM TO ASTM A38 "CARBON STRUCTURAL STEEL", UNLESS OTHERWISE INDICATED.
- ANCHOR BOLTS SHALL CONFORM TO ASTM F1554 "ANCHOR BOLTS, STEEL, 36, 55, AND 105-KSI YIELD STRENGTH". GRADE 36.
- STRUCTURAL CONNECTION BOLTS SHALL BE HIGH STRENGTH BOLTS CONFORMING TO ASTM A325 "STRUCTURAL BOLTS, STEEL, HEAT TREATED, 120/105 KSI MINIMUM TENSILE STRENGTH". BOLTS SHALL BE 3/4 INCH DIAMETER TYPE X. UNLESS OTHERWISE NOTED.
- MATCHING NUTS SHALL BE HEAVY HEX TYPE, CONFORMING TO ASTM A563 "CARBON AND ALLOY STEEL NUTS". WASHERS, WHERE REQUIRED, SHALL CONFORM TO ASTM F436 "HARDENED STEEL WASHERS".
- FIELD CONNECTIONS SHALL BE BOLTED UNLESS OTHERWISE INDICATED. ALL BOLTED CONNECTIONS SHALL BE MADE WITH NOT LESS THAN TWO (2) HIGH STRENGTH BOLTS, OR EQUIVALENT WELD.
- STRUCTURAL CONNECTIONS SHALL BE SNUG TIGHT IN ACCORDANCE WITH THE RESEARCH COUNCIL ON STRUCTURAL CONNECTIONS "SPECIFICATION FOR STRUCTURAL JOINTS USING ASTM A325 OR A490 BOLTS", UNLESS OTHERWISE
- BOLTS IN SLIP-CRITICAL CONNECTIONS SHALL BE FULLY PRETENSIONED BY THE TURN-OF-NUT METHOD IN ACCORDANCE WITH THE RESEARCH COUNCIL. ON STRUCTURAL CONNECTIONS "SPECIFICATIONS FOR STRUCTURAL JOINTS USING ASTM A325 OR A490 BOLTS"
- 11. ANCHOR BOLTS SHALL BE TENSIONED BY THE TURN-OF-NUT METHOD AFTER
- 12. CONTRACTOR SHALL COMPLY WITH AWS D1.1 "STRUCTURAL WELDING CODE -STEEL" FOR PROCEDURES, APPEARANCE AND QUALITY OF WELDS, AND FOR METHODS USED IN CORRECTING WELDING. ALL WELDERS AND WELDING PROCESSES SHALL BE QUALIFIED IN ACCORDANCE WITH AWS "STANDARD QUALIFICATION PROCEDURES". AS STEEL BAR
- 13. STEEL GRATING SHALL BE TYPE "W/B" GALVANIZED WELDED MANUFACTURED BY IKO BORDEN, OR APPROVED EQUAL, BEARING BARS SHALL DE AS FOLLOWS: GRATING 1" x 3/16" SERRATED
- 14. BAND ALL EDGES, AND ATTACH TO SUPPORTING MEMBERS AT 18" ON CENTER WITH MODEL OF CALVANIZED G-CLIPS AS MANUFACTURED BY GRATING FASTENERS INC.
- 15. EXPANSION ANCHORS SHALL BE HILTI KWIK BOLT III OR APPROVED EQUAL. INSTALLATION SHALL BE IN ACCORDANCE WITH THE MANUFACTURER'S RECOMMENDATIONS. MINIMUM EMBEDMENT SHALL BE 4-3/4" UNLESS OTHERWISE NOTED.
- 16. EPOXY ANCHOR ASSEMBLIES SHALL BE AS MANUFACTURED BY HILTI OR ENGINEER APPROVED EQUAL, AS FOLLOWS: ANCHOR SYSTEM HIT HY-200 BASE MATERIAL CONCRETE OR GROUTED CMU HIT HY-70 HOLLOW CMU
- 17. INSTALLATION SHALL BE IN ACCORDANCE WITH THE MANUFACTURER'S WRITTEN
- 18. ALL INTERIOR STRUCTURAL STEEL SHALL BE SHOP PRIME COATED WITH A RUST—INHIBITIVE PRIMER EXCEPT AREAS TO BE FIREPROOFED NEED NOT BE PAINTED. SURFACE PREPARATION SHALL BE IN ACCORDANCE WITH THE PAINT MANUFACTURER'S RECOMMENDATIONS. AREAS WHICH MAY BE INACCESSIBLE AFTER INSTALLATION SHALL RECEIVE TWO (2) COATS OF PRIMER. SEE ARCHITECTURAL GRAWINGS FOR FINISH PAINT.
- 19. FIELD CONNECTIONS AND DAMAGED OR ABRADED AREAS OF SHOP PRIME COAT SHALL BE TOUCH-UP PAINTED WITH COMPATIBLE FIELD PRIMER
- 20. ALL EXTERIOR STEEL SHALL BE GALVANIZED AFTER FABRICATION IN ACCORDANCE WITH ASTM A123 "ZINC (HOT-DIP GALVANIZED) COATINGS ON IRON AND STEEL PRODUCTS", UNLESS OTHERWISE NOTED. ALL EXTERIOR BOLTS AND MISCELLANEOUS HARDWARE SHALL BE GALVANIZED IN ACCORDANCE WITH ASTM A153 "ZINC COATING (HOT-DIP) ON IRON AND STEEL HARDWARF", UNLESS OTHERWISE NOTED.
- 1. DAMAGED GALVANIZED SURFACES SHALL BE REPAIRED BY COLD GALVANIZING IN ACCORDANCE WITH ASTM A780 "REPAIR OF DAMAGED AND UNCOATED. AREAS OF HOT-DIP GALVANIZED COATINGS".
- 22. ALL STEEL WORK SHALL BE SUBJECT TO SPECIAL INSPECTIONS DURING
- 23. THE NOTES CONTAINED HEREIN ARE NOT PROJECT SPECIFIC. THE CONTRACTOR SHALL UTILIZE ALL NOTES WHICH SOLELY PERTAIN TO THE WORK DEPICTED ON THESE DRAWINGS.

FIBER & POWER CABLE MOUNTING NOTES

- THE FIRER OPTIC TRUNK CARLES SHALL BE INSTALLED INTO CONDUITS CHANNEL CABLE TRAYS, OR CABLE TRAY, WHEN INSTALLING FIBER OPTIC TRUNK CABLES INTO A CABLE TRAY SYSTEM, THEY SHALL BE INSTALLED INTO AN INTER DUCT AND A PARTITION BARRIER SHALL BE INSTALLED BETWEEN THE 600 VOLT CABLES AND THE INTER DUCT IN ORDER TO SEGRECATE CABLE TYPES, OPTIC FIBER TRUNK CABLES SHALL HAVE APPROVED CABLE RESTRAINTS EVERY (60) SIXTY FEET AND SECURELY FASTENED TO THE CABLE TRAY SYSTEM, NEPA 20 (NEC) ARTICLE 770 BULES SHALL APPLY.
- THE TYPE TO-ER CABLES SHALL BE INSTALLED INTO CONDUITS, CHANNEL CABLE TRAYS, OR CABLE TRAY AND SHALL BE SECURED AT INTERVALS NOT EXCEEDING (6) SIX FEET. AN EXCEPTION; WHERE TYPE TC-ER CABLES ARE NOT SUBJECT TO PHYSICAL DAMAGE, CABLES SHALL BE PERMITTED TO MAKE NOT SUBJECT TO PHYSICAL DAMAGE, CABLES SHALL BE PERMITTED TO M. TRANSITION BETWEEN CONDUITS, CHANNEL CABLE TRAYS, OR CABLE TRAY PERMITTED TO MAKE A WHICH ARE SERVING UTILIZATION EQUIPMENT OR DEVICES, A DISTANCE (6) SIX FEET SHALL NOT BE EXCEEDED WITHOUT CONTINUOUS SUPPORTING. NFPA 70 (NEC) ARTICLES 336 AND 392 RULES SHALL APPLY.
- WHEN INSTALLING OPTIC FIBER TRUNK CABLES OR TYPE TO-ER CABLES INTO CONDUITS, NFPA 70 (NEC) ARTICLE 300 RULES SHALL APPLY.

ANTENNA MOUNTING NOTES

- DESIGN AND CONSTRUCTION OF ANTENNA SUPPORTS SHALL CONFORM TO CURRENT ANSI/TIA-222 OR APPLICABLE LOCAL CODES.
- ALL STEEL MATERIALS SHALL BE GALVANIZED AFTER FABRICATION IN ACCORDANCE WITH ASTM A123 "ZINC (HOT-DIP GALVANIZED) COATINGS ON IRON AND STEEL PRODUCTS", UNLESS NOTED OTHERWISE.
- 3. ALL BOLTS, ANCHORS AND MISCELLANEOUS HARDWARE SHALL BE GALVANIZED IN ACCORDANCE WITH ASTM A153 "ZINC-COATING (HOT-DIP) ON IRON AND STEEL HARDWARE", UNLESS NOTED OTHERWISE.
- DAMAGED GALVANIZED SURFACES SHAUL BE REPAIRED BY COLD GALVANIZING IN ACCORDANCE WITH ASTM A780.
- 5. ALL ANTENNA MOUNTS SHALL BE INSTALLED WITH LOCK NUTS, DOUBLE NUTS AND SHALL BE TORQUED TO MANUFACTURER'S RECOMMENDATIONS.
- CONTRACTOR SHALL INSTALL ANTENNA PER MANUFACTURER'S RECOMMENDATION FOR INSTALLATION AND GROUNDING.
- ALL UNUSED PORTS ON ANY ANTENNAS SHALL BE TERMINATED WITH A 50-OHM LOAD TO ENSURE ANTENNAS PERFORM AS DESIGNED
- PRIOR TO SETTING ANTENNA AZIMUTHS AND DOWNTILTS, ANTENNA CONTRACTOR SHALL CHECK THE ANTENNA MOUNT FOR TIGHTNESS AND ENSURE THAT THEY ARE PLUMB, ANTENNA AZIMUTHS SHALL BE SET FROM TRUE NORTH AND BE ORIENTED WITHIN +/- 5% AS DEFINED BY THE RFDS, ANTENNA DOWNTILTS SHALL BE WITHIN +/- 0.5% AS DEFINED BY THE RFDS. REFER TO
- 9. JUMPERS FROM THE TMA'S MUST TERMINATE TO OPPOSITE POLARIZATION'S IN
- CONTRACTOR SHALL RECORD THE SERIAL #, SECTOR, AND POSITION OF EACH ACTUATOR INSTALLED AT THE ANTENNAS AND PROVIDE THE INFORMATION TO
- 11. TMA'S SHALL BE MOUNTED ON PIPE DIRECTLY BEHIND ANTENNAS AS CLOSE TO ANTENNA AS FEASIBLE IN A VERTICAL POSITION.
- 12. ANTENNAS SHALL HAVE A 6'-0" MIN CENTER TO CENTER HORIZONTAL SEPARATION BETWEEN SIMILAR TECHNOLOGIES (U.N.O.).

TORQUE REQUIREMENTS

- ALL RF CONNECTIONS SHALL BE TIGHTENED BY A TORQUE WRENCH.
- ALL RF CONNECTIONS, GROUNDING HARDWARE AND ANTENNA HARDWAR SHALL HAVE A TORQUE MARK INSTALLED IN A CONTINUOUS STRAIGHT LINE FROM BOTH SIDES OF THE CONNECTION.
- A. RF CONNECTION BOTH SIDES OF THE CONNECTOR
- B. GROUNDING AND ANTENNA HARDWARE ON THE NUT SIDE STARTING FROM THE THREADS TO THE SOLID SURFACE, EXAMPLE OF SOLID SURFACE: GROUND BAR, ANTENNA BRACKET METAL
- 3. ALL 8M ANTENNA HARDWARE SHALL BE TIGHTENED TO 9 LB-FT (12 NM).
- 4. ALL 12M ANTENNA HARDWARE SHALL BE TIGHTENED TO 43 LB-FT (58 NM).
- ALL GROUNDING HARDWARE SHALL BE TIGHTENED UNTIL THE LOCK WASHER COLLAPSES AND THE GROUNDING HARDWARE IS NO LONGER LOOSE. 6. ALL DIN TYPE CONNECTIONS SHALL BE TIGHTENED TO 18-22 LB-FT (24.4
- 29.8 NM). 7. ALL N TYPE CONNECTIONS SHALL BE TIGHTENED TO 15-20 LB-IN (1.7 -2.3 NM)



NEW CINCULAR WIRELESS PCS, LLC ONE AT&T WAY REDMINSTER, NJ 07921



BLACK & VEATCH ACK & VEATCH CORPOR 650 FROM RD, SUITE 5 PARAMUS, NJ 07652


UNDER CONTRACT WITH OVERLAND CONTRACTING INC

TECTONIC

- SURVEYING
 CONSTRUCTION MANAGENENT

Phones (843) 567-5656 Fest (845) 567-6703 www.tecton/candinasrina

PROJECT NO 8002.NYCWNY4003 DRAWN BY: MP CHECKED BY GL.

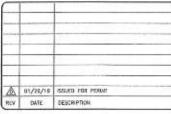



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SITE NAME: WARWICK CENTRAL SITE NO. NYCWNY4003 ADDR: 15 MAPLE AVENUE WARWICK, NY 10990

> SHEET TITLE NOTES

SHEET NUMBER

A-6

THIS SET OF DRAWINGS SHALL NOT BE USED FOR CONSTRUCTION PURPOSES UNTIL THE DRAWINGS HAVE BEEN MARKED "ISSUED FOR SCOPE CONSTRUCTION" BY TECTONIC. LTF 2C OBIGINAL SIZE IN INCHES REFER TO LATEST RF DATA SHEET FOR

FINAL RE DESIGN & BOW.

NOTES LEGEND GROUNDING IS SHOWN DIAGRAMMATICALLY ONLY. CONTACTOR SHALL GROUND ALL EQUIPMENT AS A COMPLETE SYSTEM. GROUNDING SHALL BE IN COMPLENCE WITH NEC SECTION 250 AND AT&T CADWELD CONNECTION ■ MECHANICAL CONNECTION GROUNDING AND BONDING REQUIREMENTS (ATT-TP-78416) AND MANUFACTURER'S SPECIFICATIONS. ALL GROUNDING CONDUCTORS SHALL BE COPPER; NO ALUMINUM (TYPICAL PER SECTOR) CONDUCTORS SHALL BE USED; TECTORIC TAKES NO LIABILITY OR RESPONSIBILITY FOR THE ONE-LINE DIAGRAM SHOWN ABOVE THIS IS A GENERIC DIAGRAM PROVIDED BY THE CLIENT, CONTRACTOR SHALL THEREFORE, FIELD VERIFY EXISTING CONDITIONS RIOR TO IMPLEMENTATION. IPPRESSE DEVICE - EXIST GROUND BAR #2 AWG EXIST ATAT GROUND BAR Dill EXIST AT&T EQUIPMENT PLATFORM EXIST GROUND TO GROUND SOURCE

GROUNDING PLAN

SCALE: NTS

GROUNDING KEY NOTES

A. EXTERIOR GROUND RING: #2 AWG SOLID COPPER, BURIED AT A DEPTH OF AT LEAST 30 INCHES BELOW GRADE, OR 6 INCHES BELOW THE FROST LINE AND APPROXIMATELY 24 INCHES FROM THE EXTERIOR WALL, DR FOOTING. (ATT-TP-76416 2.2.3.5/7.5.1)

TOWER GROUND RING: THE GROUND RING SYSTEM SHALL BE INSTALLED AROUND AN ANTENNA TOWER'S LEGS, AND/OR GUY ANCHORS. WHERE SEPARATE SYSTEMS HAVE BEEN PROVIDED FOR THE TOWER AND THE BUILDING, AT LEAST TWO BONDS SHALL BE MADE BETWEEN THE TOWER RING GROUND SYSTEM AND THE BUILDING RING GROUND SYSTEM USING MINIMUM #2 AWG SOLID COPPER CONDUCTORS (ATT-TP-76416 7.5.1)

INTERIOR GROUND RING: \$2 AWG STRANDED CREEN INSULATED COPPER CONDUCTOR EXTENDED AROUND THE PERIMETER OF THE EQUIPMENT AREA, ALL NON-TELECOMMUNICATIONS RELATED METALLIC OBJECTS FOUND WITHIN A SITE SHALL BE GROUNDED TO THE INTERIOR GROUND RING WITH #6 AWG STRANDED GREEN INSULATED CONDUCTOR. (ATT-TP-78416 7.8.4)

BOND TO INTERIOR GROUND RING: #2 AWG SOLID TINNED COPPER WIRE PRIMARY BONDS SHALL BE PROVIDED AT LEAST AT FOUR POINTS ON THE INTERIOR GROUND RING, LOCATED AT THE CORNERS OF THE BUILDING. (ATT-TP-76416 7.5.2.2)

GROUND ROD: UL LISTED COPPER CLAD STEEL. MINIMUM 5/8"DIAMETER BY EIGHT FEET LONG. ALL GROUND RODS SHALL BE INSTALLED WITH INSPECTION SLEEVES, GROUND RODS SHALL BE DRIVEN TO THE DEPTH OF GROUND RING CONDUCTOR. (ATT-TP-76416 1.4 / 7.5.1)

CELL REFERENCE GROUND BAR: POINT OF GROUND REFERENCE FOR ALL COMMUNICATIONS EQUIPMENT FRAMES. ALL BONDS ARE MADE WITH #2 AWG STRANDED GREEN INSULATED COPPER CONDUCTORS. BONI TO GROUND RING WITH (2) #2 SOLID TINNED COPPER CONDUCTORS. (ATT. 76416 7.6.5)

G. HATCH PLATE GROUND BAR: BOND TO THE INTERIOR GROUND RING WITH TWO #2 AWG STRANDED GREEN INSULATED COPPER CONDUCTORS, WHEN A HATCH-PLATE AND A CELL REFERENCE GROUND BAR ARE BOTH PRESENT, THE CRGB MUST BE CONNECTED TO THE HATCH-PLATE AND TO THE INTERIOR GROUND RING USING TWO \$2 AWG STRANDED GREEN INSULATED COPPER CONDUCTORS.
H. EXTERIOR CABLE ENTRY PORT GROUND BARS: LOCATED AT THE ENTRANCE TO THE CELL SITE BUILDING

BOND TO GROUND RING WITH A #2 AWG SOLID TINNED COPPER CONDUCTORS WITH AND EXCIHERMIC WELD AND INSPECTION SLEEVE. (ATT-TP-76416 7.6.7.2)

TOWER EXIT GROUND BAR: #2 AWG SOLID TINNED COPPER BOND TO THE TOWER GROUND RING.

(ATT-TP-76418 7.55)
TELCO GROUND BAR: BOND TO BOTH CELL REFERENCE GROUND BAR AND EXTERIOR GROUND RING. (ATT-TP-76418 7.6.8)

FRAME BONDING: THE BONDING POINT FOR TELECOM EQUIPMENT FRAMES SHALL BE THE GROUND BUS THAT IS NOT ISOLATED FROM THE EQUIPMENTS METAL FRAMEWORK, BOND THE FRAME GROUND BUS TO

THE TISECTION OF THE CELL REFERENCE GROUND BAR, (ATT-TP-76416 7.8) INTERIOR UNIT BONDS: METAL FRAMES, CABINETS AND INDIVIDUAL METALLIC UNITS LOCATED WITH THE AREA OF THE INTERIOR GROUND RING REQUIRE A #6 AWG STRANDED GREEN INSULATED COPPER BOND TO THE INTERIOR GROUND RING. (ATT-TP-76416 7.12.3.1)

FENCE AND CATE GROUND RING. [ATI-IP-75416 7.12.3.1]
FENCE AND CATE GROUND: METAL FENCES WITHIN 7 FEET OF THE EXTERIOR GROUND RING OR OBJECTS
BONDED TO THE EXTERIOR GROUND RING SHALL BE BONDED TO THE GROUND RING WITH A #2 AWG
SOLID TINNED COPPER CONDUCTOR AT AN INTERVAL NOT EXCEEDING 25 FEET, BONDS SHALL BE MADE
AT EACH GATE POST AND ACROSS GATE OPTINIOS. (ATT-IP-75416 7.12.2.2)

EXTERIOR UNIT BONDS: METALLIC OBJECTS, EXTERNAL TO OR MOUNTED TO THE BUILDING, SHALL BE BONDED TO THE EXTERIOR GROUND RING. (ATT-TP-76416 7.4.2.6)

ICE BRIDGE SUPPORTS: EACH ICE BRIDGE LEG SHALL BE BONDED TO THE GROUND RING WITH #2 AWG BARE TINNED COPPER CONDUCTOR, PROVIDE EXOTHERMIC WELDS AT BOTH THE ICE BRIDGE LEG AND BURIED GROUND RING. (ATT-TP-76416 7.4.2.6)

GROUNDING NOTES

1. THE ENTIRE ELECTRICAL INSTALLATION SHALL BE GROUNDED AS REQUIRED BY ALL APPLICABLE CODES.

THE ENTRE ELECTRICAL INSTALLATION SHALL BE GROUNDED AS REQUIRED BY ALL APPLICABLE CODES.
ALL GROUNDING WORK SHALL BE IN ACCORDANCE WITH ATACT.
ALL BUS CONNECTORS SHALL BE TWO—HOLE, LONG—BARREL TYPE COMPRESSION LUGS, T&B OR EQUAL,
UNLESS DIHERWISE MOTED ON DRAWINGS, ALL LUGS SHALL BE ATTACHED TO BUSSES USING BOLLS,
NUTS, AND LOCK WASHERS. NO WASHERS ARE ALLOWED BETWEEN THE TEMS BEING GROUNDED.
ALL CONNECTORS SHALL BE CRIMPED USING HYDRAULIC CRIMPING TOOLS, T&B #TBM 8 OR EQUIVALENT.
ALL CONNECTORS SHALL BE MADE TO BARE METAL. ALL PAINTED SURFACES SHALL BE FILED TO
ENSURE PROPER CONTACT, NO WASHERS ARE ALLOWED BETWEEN THE ITEMS BEING GROUNDED. ALL
CONNECTIONS ARE TO HAVE A NON—CONDIZING AGENT APPLIED PRIOR TO INSTALLATION.

NO CORDER DELECTRICAL PROPERTY AND A NON—CONDIZING AGENT APPLIED PRIOR TO INSTALLATION.

8. ALL COPPER BUSSES SHALL BE CLEANED, POLISHED, AND A NON-OXIDIZING AGENT APPLIED. NO FINGERPRINTS OR DISCOLORED COPPER WILL BE PERMITTED.
7. ALL BENDS SHALL BE AS SHALLOW AS POSSIBLE, WITH NO TURN SHORTER THAN AN 8-INCH NOMINAL

RADIUS.

RADIUS CONDUCTORS SHALL BE SQLIO TINNED COPPER AND ANNEALED #2. ALL GROUNDING CONDUCTORS SHALL RUN THROUGH PVC SLEEVES WHEREVER CONDUCTORS RUN THROUGH WALLS, FLOORS, OR CEILINGS. IF CONDUCTORS MUST RUN THROUGH EMT, BOTH ENDS OF CONDUCT SHALL BE GROUNDED. SEAL BOTH ENDS OF CONDUIT WITH SILICONE CAULK.

9. GROUNDING SYSTEM RESISTANCE SHALL NOT EXCEED 10 OHMS, IF THE RESISTANCE VALUE IS EXCEEDED, NOTHY THE PROJECT MANAGER FOR FURTHER INSTRUCTION ON METHODS FOR REDUCING THE

RESISTANCE VALUE.

IO. ALL ROOF TOP ANTENNA MOUNTS SHALL BE GROUNDED WITH A #2 GROUND WIRE CONNECTED TO THE

NEAREST GROUND BUS, ALL CONNECTIONS ARE TO BE CAD-WELDED IF POSSIBLE.

11. UPON COMPLETION OF WORK, CONDUCT CONTINUITY, SHORT CIRCUIT, AND FALL OF POTENTIAL GROUNDING TESTS FOR APPROVAL. SUBMIT TEST REPORTS TO THE PROJECT MANAGER.

GROUNDING CONNECTION TO TRAVEL IN A DOWNWARD DIRECTION. 13. ALL EXPOSED #2 WIRE MUST BE TINN NOT BTW.

15. ALL EAROUSED #2 WPC, #2 AND BARE TINNED SOUD COPPER CONDUCTORS TO GROUNDING BAR, ROUTE CONDUCTORS TO BURIED GROUNDING RING AND PROVIDE PARALLEL EXOTHERMIC WELD.

15. ALL GROUNDING BARS SHALL BE STAMPED IN TO THE METAL "IF STOLEN DO NOT RECYCLE." THE CONTRACTOR SHALL USE PERMANENT MARKER TO DRAW THE LINES BETWEEN EACH SECTION AND LABEL EACH SECTION ("P", "A", "N", "1") WITH 1" HIGH LETTERS.

16. ALL HARDWARE SHALL BE STAINLESS STEEL 3/8" DIMETER OR LARGE. ALL HARDWARE 18—8 STAINLESS

STEEL INCLUDING LOCK WASHERS, COAT ALL SURFACES WITH AN ANTI-OXIDANT COMPOUND BEFOR 17. FOR GROUND BOND TO STEEL ONLY: INSERT A CADMIUM FLAT WASHER BETWEEN LUG AND STEEL, COAT

ALL SURFACES WITH AN ANTI-OXIDANT COMPOUND BEFORE MATING,
18. DO NOT INSTALL CABLE GROUNDING KIT AT A BEND AND ALWAYS DIRECT GROUNDING CONDUCTOR DOWN

TO CROUNDING BUS.

19. NUT & WASHER SHALL BE PLACED ON THE FRONT SIDE OF THE GROUNDING BAR AND BOLTED ON THE BACK SIDE, INSTALL BLACK HEAT—SHRINKING TUBE, 800 VOLT INSULATION, ON ALL GROUNDING TERMINATIONS. THE INTENT IS TO WEATHERPROOF THE COMPRESSION CONNECTION.

20. SUPPLIED AND INSTALLED BY CONTRACTOR,
21. THE CONTRACTOR SHALL BE RESPONSIBLE FOR INSTALLING ADDITIONAL GROUNDING BAR AS REQUIRED. PROVIDING 50% SPARE CONNECTION POINTS. 22. ENSURE THE WIRE INSULATION TERMINATION IS WITHIN 1/8" OF THE BARREL (NO SHINERS).

THIS SET OF DRAWINGS SHALL NOT BE USED DRAWINGS HAVE BEEN MARKED "ISSUED FOR SCOPE CONSTRUCTION" BY TECTONIC LTE 2C ORIGINAL SIZE IN REFER TO LATEST HE DATA SHEET FOR FINAL RF DESIGN & BOM.



NEW CINGULAR WIRELESS PCS, LLC ONE ATAT WAY BEDWINSTER, NJ 07921



PARAMUS, NJ 07652

UNDER CONTRACT WITH

TECTONIC

- SURVEYING CONSTRUCTION MANAGEMENT

TECTORIO Engineering & Burveying Consultonia P.C. 1278 HOUTE 200 Phone: (845) 567-5656 Fax: (845) 567-6703

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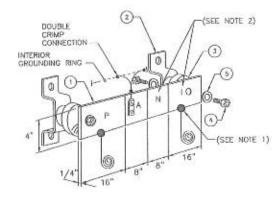
SHEET TITLE

GROUNDING PLAN & NOTES

SHEET NUMBER

G-1

	NEWTO	UNSTRUMENT CO BUTNER, N.C	
NO	REQUIRED	PART NUMBER	DESCRIPTION
0	1	1/4"x4"x48"	SOLID GROUNDING BAR
3	2	A-6056	WALL MOUNTING BRACKET
(3)	2	3061-4	INSULATORS
0	4	3012-1	5/8"-11x1" H.H.C.S
(9)	4	3015-8	5/8* LOCKWASHER



(MGB) REFERENCE GROUNDING BAR G-2 SCALE: NTS

EACH GROUNDING CONDUCTOR TERMINATING ON ANY GROUNDING BAR SHALL HAVE AN IDENTIFICATION TAG ATTACHED AT EACH END THAT WILL IDENTIFY ITS ORIGIN AND DESTINATION

SECTION "P" - SURGE PROTECTORS

(EC) CELL REFERENCE GROUNDING BAR (IF COLLOCATED)

(EC) GENERATOR FRAMEWORK (IF AVAILABLE) (#2 AWG)

(EC) TELCO GROUNDING BAR (#2 AWG)

(EC) COMMERCIAL POWER COMMON NEUTRAL/GROUNDING BOND (3/0)

(EC) FIBER GROUNDING BAR (#2 AWG)

(EC) POWER ROOM REFERENCE GROUNDING BAR (#2 AWG) (AT&T) RECTIFIER FRAMES

SECTION "A" - SURGE ABSORBERS

(EC) INTERIOR GROUNDING RING (#2 AWG)

(EC) EXTERNAL EARTH GROUNDING FIELD (BURIED GROUNDING

RING) (#2 AWG)
(EC) METALLIC COLD WATER PIPE (IF AVAILABLE) (1/0 AWG) (EC) BUILDING STEEL (IF AVAILABLE) (1/0 AWG)

SECTION "N" - NON-ISOLATED GROUNDING ZONE EQUIPMENT

(EC) MISC. NON-ISOLATED GROUNDING ZONE EQUIPMENT (AT&T)-48V POWER SUPPLY RETURN BARE

SECTION "\" - ISOLATED GROUNDING ZONE

(AT&T) ALL ISOLATED GROUNDING REFERENCE

(ATAT) GROUNDING WINDOW BAR

CENERIC DETAILS, CONTRACTOR TO FIELD VERIFY EXISTING CONDITIONS PRIOR TO IMPLEMENTATION, CONTACT CONSTRUCTION MANAGER AND/OR DESIGN ENGINEER FOR APPROVAL.

ELECTRICAL NOTES

- THE CONTRACTOR IS RESPONSIBLE FOR OBTAINING AND COORDINATING ALL REQUIRED LOCAL BUILDING DEPARTMENT INSPECTIONS AND APPROVALS. ALL ELECTRICAL WORK IS TO BE PERFORMED BY AN INDMIDUAL LICENSED IN THE JURISDICTION OF THE
- THE ENTIRE SYSTEM SHALL CONFORM TO ALL STATE AND LOCAL BUILDING CODES AND THE LATEST ADOPTED ADDITION OF THE NATIONAL ELECTRIC CODE.
- 3. THE CONTRACTOR SHALL FURNISH AND INSTALL ALL ITEMS INDICATED ON THESE
- 4. ALL EXTERIOR DEVICES SHALL BE RATED FOR EXTERIOR USE "3R".
- 5. THE CONTRACTOR IS RESPONSIBLE FOR ALL CLEARING AND EXCAVATING FOR NEW UTILITY POLES OR UNDERGROUND UTILITY RUNS. COORDINATE WITH THE LOCAL UTILITY COMPANIES TO DETERMINE WHAT DEVICES ARE SUPPLIED AND INSTALLED AS THE SECONDARY ELECTRIC AND TELEPHONE SERVICE VERSUS UTILITY COMPANIES
- ALL MATERIALS AND DEVICES INSTALLED SHALL BE NEW AND IN WORKING ORDER. DEVICES AND MATERIALS SHALL BE LISTED AND BEAR THE "UL" SEAL OF APPROVAL AND INSPECTION LABEL "J".
- 7. THE CONTRACTOR IS TO DEMONSTRATE TO A CLIENT'S PROJECT MANAGER THAT THE SYSTEM IS FULLY ENERGIZED AND WORKING AS INTENDED. CONDUCT CONTINUITY, SHORT CIRCUIT AND FALL OF POTENTIAL GROUNDING TEST. SUBMIT TEST RESULTS TO THE PROJECT MANAGER.
- B. ALL ELECTRICAL EQUIPMENT SHALL BE LABELED WITH PERMANENT ENGRAVED PLASTIC
- EACH CONDUCTOR OF EVERY SYSTEM SHALL BE PERMANENTLY TAGGED IN EACH PANEL BOARD, PULL BOX, J-BOX, SWITCH PLATE, ETC., IN COMPLIANCE WITH OSHA
- 10. LABEL EACH PANEL BOARD CIRCUIT DIRECTORY CARD, IDENTIFY THE "LOAD SERVED". "SPARE" OR "SPACE"
- 11. THE ENTIRE ELECTRICAL SYSTEM SHALL BE GROUNDED. GROUNDING SHALL BE #2 AWG SOUD TINNED ANNEALED COPPER, LINLESS OTHERWISE NOTED.
- THE CONTRACTOR IS RESPONSIBLE FOR ALL TRENCHING, BACK FILLING AND REPAIRING OF EXISTING SURFACES CUT AND REMOVED FOR UNDERGROUND UTILITY
- 13. THE CONTRACTOR IS RESPONSIBLE FOR ALL CUTTING, PATCHING, DRILLING, CHASING . THE CONTROLOR IS RESPONSIBLE FOR ALL COTTING, PARTHING, UNBELLING, CHASHING, HOLES AND SLEEVES IN EXISTING BUILDING WALLS AND FLOORS REQUIRED TO INSTALL THE NEW ELECTRICAL SERVICE, FIRE —RATED WALL SHALL BE PATCH WITH SM FIRE SEAL OR EQUIAL, RATING AS REQUIRED. ALL PENETRATIONS THRU EXTERIOR WALLS SHALL BE CAULKED WEATHER TICHT.
- 14. THE CONTRACTOR IS TO SUPPLY ALL HANGERS, SUPPORTS, FASTENERS AND HARDWARE FOR A COMPLETE INSTALLATION, ALL OF THE ABOVE SHALL BE ZING—COALED. IT IS THE RESPONSIBILITY OF THE CONTRACTOR TO VERIFY ALL FIELD CONDITIONS PRIOR TO ORDERING LENGTHS OF MATERIAL.
- 15. PRIOR TO THE WIRE INSTALLATION OR BACK FILL OF THE UTILITY TRENCH, THE CONTRACTOR IS TO COORDINATE ALL INSPECTIONS OF THE CONDUIT, SWEEPS AND ANY UTILITY POLE RISERS WITH THE LOCAL UTILITY COMPANY.
- 15. ALL SECONDARY CONDUITS USED FOR EXTERIOR UNDERGROUND UTILITIES SHALL BE PVC SCHEDULE #40, SCHEDULE #80 UNDER ROADWAYS. MINIMUM BEND RADIUS SHALL BE 36". ALL CONDUITS SHALL HAVE MINIMUM OF TWO (2) DRAG LINES, PULL BOXES ARE TO BE INSTALLED WHEN LENGTHS EXCEED 100 FEET. COORDINATE SIZE OF CONDUITS REQUIRED BY THE UTILITY COMPANIES.
- ALL CIRCUIT BREAKERS, FUSES AND FIELD INSTALLED ELECTRICAL EQUIPMENT SHALL HAVE AN INTERRUPTING RATING NOT LESS THAN THE MAXIMUM SHORT CIRCUIT TO WHICH THEY MAY BE SUBJECT AND MINIMUM RATING OF 22,000 A.L.C.
- 18. GENERAL CONTRACTOR IS TO COORDINATE ALL OF HIS WORK TO MINIMIZE THE DISTURBANCE TO THE EXISTING SITE OCCUPANTS! WORKERS OR ACCESS REQUIRED BY THE GENERAL PUBLIC OR MAINTENANCE PERSONNEL.
- ANY DISRUPTION OF THE EXISTING ELECTRICAL SERVICE MUST BE COORDINATED WITH THE OTHER SITE OCCUPANTS.
- ANY DISRUPTION OF THE EXISTING SITE CONDITIONS SHALL BE RETURNED TO THEIR PREVIOUS CONDITION OR BETTER.



NEW CINCULAR WIRELESS PCS, LLC ONE AT&T WAY BEDMINSTER, NJ 07921



BLACK & VEATCH

BLACK & VEATCH CORPORATIO 650 FROM RD, SUITE 575, PARAMUS, NJ 07652

UNDER CONTRACT WITH



- CONSTRUCTION MANAGEMENT
- TEXTOMS Engineering & Surreying Consultants P.C. 1279 ROUTE 300

Phone: (845) 557-6696 Fac: (846) 567-8703

PRO	MECT NO:	8	8002.NYCWNY4003					
DRA	WN BY:		MP					
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	-							
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REV	DATE	DESCRIPTION						



COPIES OF THIS DOCUMENT WITHOUT AN ORIGINAL SIGNATURE AND AN ORIGINAL EMBOSSED SEAL OF THE PROFESSIONAL ENGINEER OR LAND SURVEYOR SHALL NOT BE CONSIDERED VALID COPIES.

SITE NAME: WARWICK CENTRAL SITE NO. NYCWNY4003 ADDR: 15 MAPLE AVENUE WARWICK, NY 10990

SHEET TITLE GROUNDING DETAILS & ELECTRICAL NOTES

SHEET NUMBER

G-2

THIS SET OF DRAWINGS SHALL NOT BE USED FOR CONSTRUCTION PURPOSES UNTIL THE DRAWINGS HAVE BEEN MARKED "ISSUED FOR SCOPE CONSTRUCTION" BY TECTONIC. LTE 2C SOCOO STATE OF THE REFER TO LATEST RF DATA SHEET FOR

FINAL RF DESIGN & BOM.

EXHIBIT D



Radio Frequency Safety Survey Report Prediction (RFSSRP) Prepared For:



Site Name: Warwick Central

FA#:

10133512

USID:

106838

Site ID:

NYCWNY4003

Address: 15 Maple Avenue

Warwick, NY 10990

County:

Orange

Latitude: N41-15-40.80

Longitude: W74-21-27.00


Additional Site Information

M-RFSC Name:

Michael Kazigian

Site Structure Type:

Rooftop

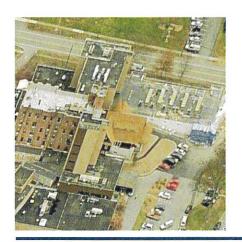

Report Information

Report Writer:

Jeffrey Schwartz

Report Generated Date: February 15, 2016

Compliance Statement

AT&T Mobility Compliance Statement: Based on the information collected, AT&T Mobility is Compliant with FCC Rules and Regulations.




Site Name: Warwick Central

Site FA: 10133512

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Site FA: 10133512

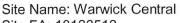

1 General Summary

1.1 Site Summary


Existing RF Sign(s) at Access Point(s)	Information 1
Existing RF Sign(s) at AT&T Mobility Sectors	Alpha: None
	Beta: Information 1/ Caution
	Gamma: Information 1
Existing Barriers at AT&T Mobility Sectors	Beta
Existing RF Signs at Other Carrier Sectors	None
Existing RF Barriers at Other Carrier Sectors	None
Max Predictive Spatial Average MPE% &	2942.17% in front of AT&T Mobility Gamma
Location on Roof (General Public)	Sector Antenna #6
Max Predictive Spatial Average MPE% at	0.0086% MPE
Ground (General Public)	

Site Name: Warwick Central

Site FA: 10133512



2 Site Scale Map

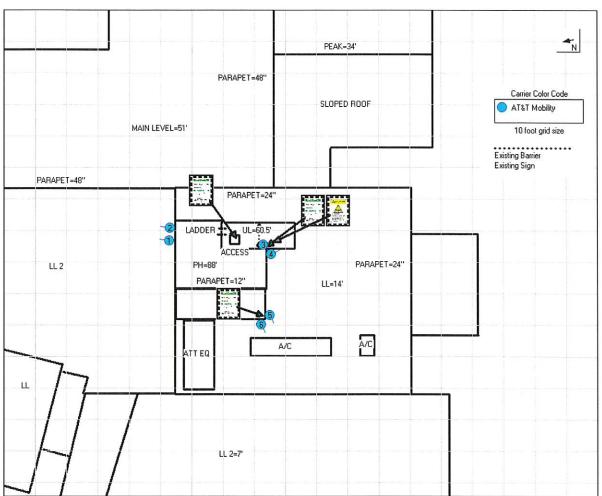

Signs Required for Compliance (AT&T Mobility Only)



Site Name: Warwick Central Site FA: 10133512

3 Antenna Inventory

nten	na mvem	OI y															
							Horizontal		bas no					11110000 200			
							Beam		Antenna				Total	Mech.			Z Bottom
		Antenna			Frequency	Az	width	Ant	Gain	GSM	LTE	UMTS	ERP	DT	X	Y	Tip Ground
Ant#	Operator	Make	Antenna Model	Type	(MHz)	(deg)	(deg)	(ft)	(dBd)	Radios	Radios	Radios	(watts)	(deg)	(ft)	(ft)	Level (ft)
1	AT&T Mobility	QUINTEL	QS6658-2 08DT	Panel	850	20	61	6.0	11.95			1	627	0	13	52	82.9
1	AT&T Mobility	QUINTEL	QS6658-2 02DT	Panel	1900	20	54	6.0	14.95			1	1250	0	13	52	82.9
2	AT&T Mobility	QUINTEL	QS6658-3-01DT	Panel	700	20	72	6.0	11.15		1		1043	0	13	56	82.9
2	AT&T Mobility	QUINTEL	QS6658-3-02DT	Panel	850	20	65	6.0	11.55	2			472	0	13	56	82.9
2	AT&T Mobility	QUINTEL	QS6658-3-08DT	Panel	1900	20	71	6.0	15.65		1		2203	0	13	56	82.9
2	AT&T Mobility	QUINTEL	QS6658-3-01DT	Panel	1900	20	72	6.0	15.55		1		2153	0	13	56	82.9
3	AT&T Mobility	QUINTEL	QS6658-2 08DT	Panel	850	170	61	6.0	11.95			1	627	0	43	51	82.9
3	AT&T Mobility	QUINTEL	QS6658-2 02DT	Panel	1900	170	54	6.0	14.95			1	1250	0	43	51	82.9
4	AT&T Mobility	QUINTEL	QS6658-3-01DT	Panel	700	170	72	6.0	11.15		1		1043	0	46	48	82.9
4	AT&T Mobility	QUINTEL	QS6658-3-02DT	Panel	850	170	66	6.0	11.45	2			472	0	46	48	82.9
4	AT&T Mobility	QUINTEL	QS6658-3-08DT	Panel	1900	170	71	6.0	15.65		1	William I	2203	0	46	48	82.9
4	AT&T Mobility	QUINTEL	QS6658-3-01DT	Panel	1900	170	72	6.0	15.55		1		2153	0	46	48	82.9
5	AT&T Mobility	QUINTEL	QS6658-2 08DT	Panel	850	255	61	6.0	11.95			1	627	0	45	28	82.9
5	AT&T Mobility	QUINTEL	QS6658-2 02DT	Panel	1900	255	54	6.0	14.95			1	1250	0	45	28	82.9
6	AT&T Mobility	QUINTEL	QS6658-3-01DT	Panel	700	255	72	6.0	11.15		1		1043	0	43	25	82.9
6	AT&T Mobility	QUINTEL	QS6658-3-02DT	Panel	850	255	65	6.0	11.55	2			472	0	43	25	82.9
6	AT&T Mobility	QUINTEL	QS6658-3-08DT	Panel	1900	255	71	6.0	15.65		1		2203	0	43	25	82.9
6	AT&T Mobility	QUINTEL	QS6658-3-01DT	Panel	1900	255	72	6.0	15.55		1		2153	0	43	25	82.9

Note: Waterford Consultants has assumed transmission parameters for Unknown RF emitters based on similar installations found at other radio communications sites. Generic antenna models have been used where existing antenna part numbers or radiation patterns are not available. The frequencies presented in this table may have been assumed in order to represent the approximate band of operation and to support a worst-case calculation of power density.



Site Name: Warwick Central


Site FA: 10133512

4 Predicted Emission Levels and Discussion


The following plots show the spatial average predicted power density levels in the reference plane indicated as a percentage of the General Public Limits. Please note that 100% of the General Public Limits corresponds to 20% of the Occupational Limits.

The reference plane for the plot is the roof level, as indicated in the caption. For example, "Avg 10 to 16 Feet" refers to the spatial average predicted power density level between 10 and 16 feet above the main level. Plots are produced for each accessible level. Levels that are not accessible will not be shown. Only accessible areas in a plot are relevant. Areas not accessible or in free space, off the edge of a roof or equipment penthouse, do not affect compliance.


4.1 Predictive AT&T Mobility's RF Contribution Only on the Site

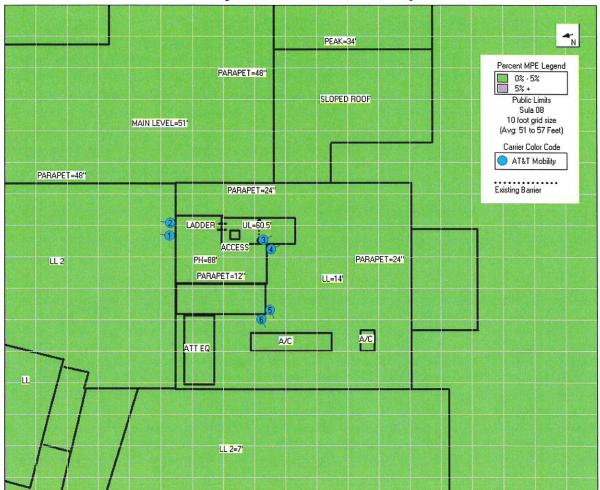

The reference plane for the plot is the main level.

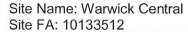




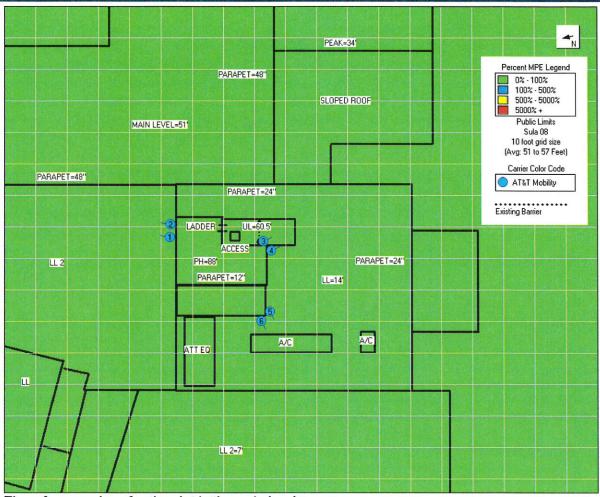

The reference plane for the plot is the main level.




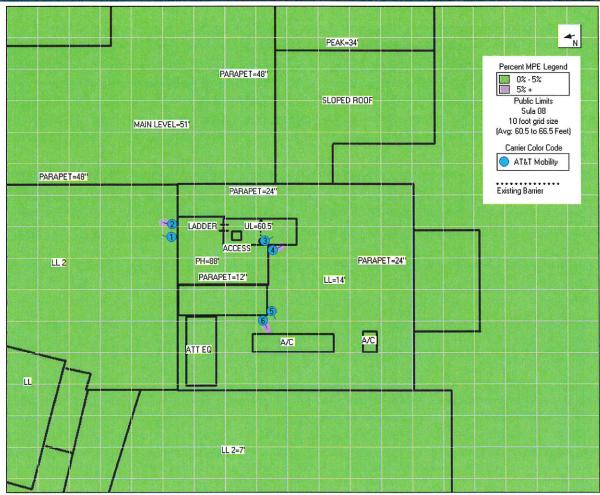

The reference plane for the plot is the upper level.




Site FA: 10133512

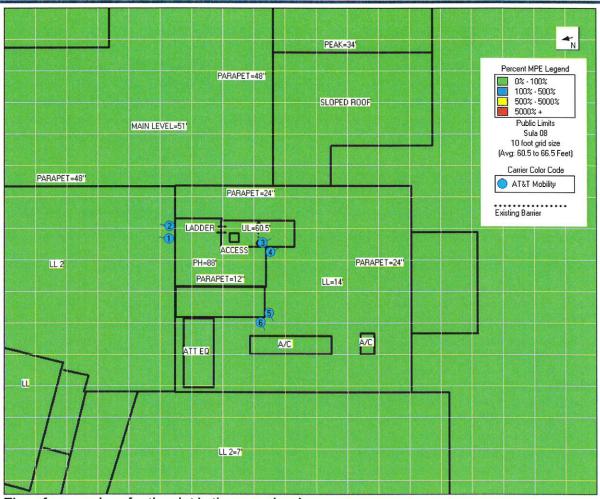


The reference plane for the plot is the upper level.



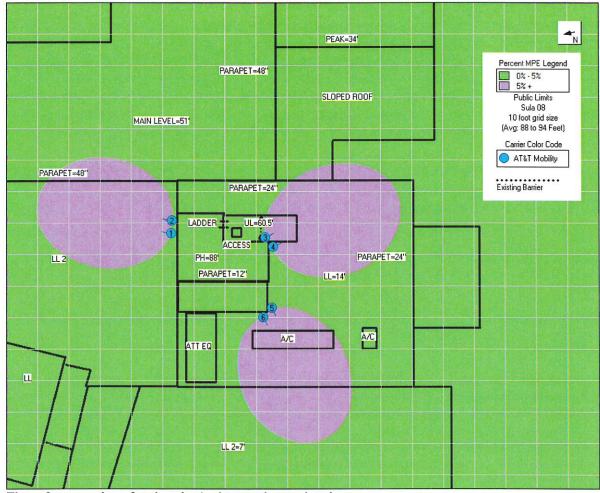


The reference plane for the plot is the penthouse level.




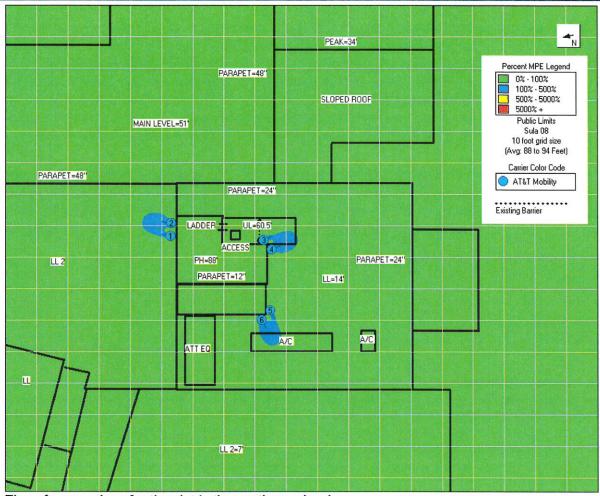


The reference plane for the plot is the penthouse level.

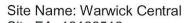




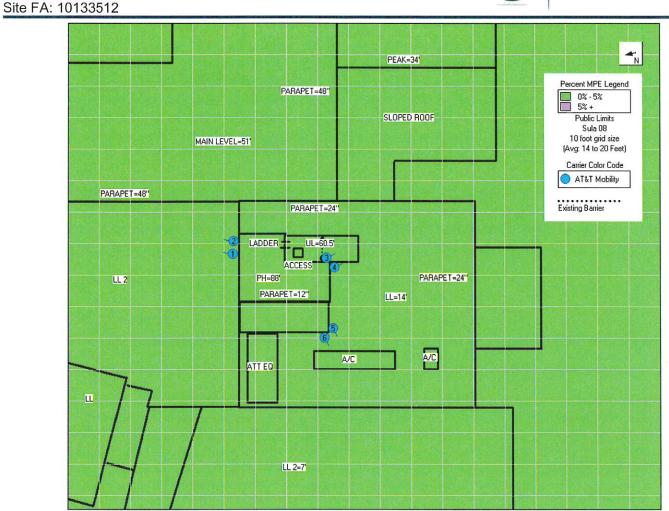

The reference plane for the plot is the lower level.

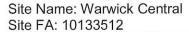




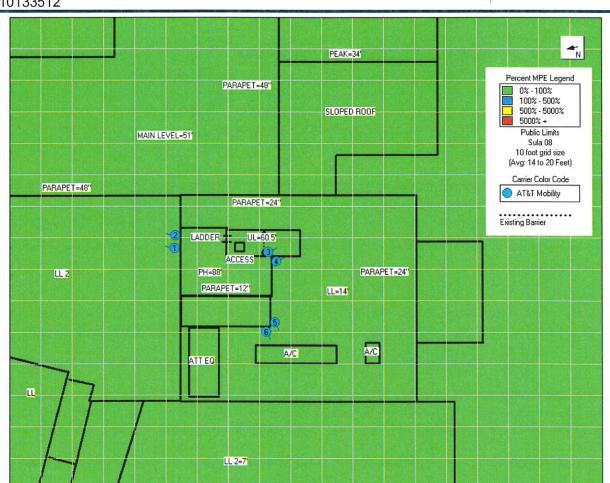

The reference plane for the plot is the lower level.



4.2 Predictive RF Contribution from All Sources at Ground Level

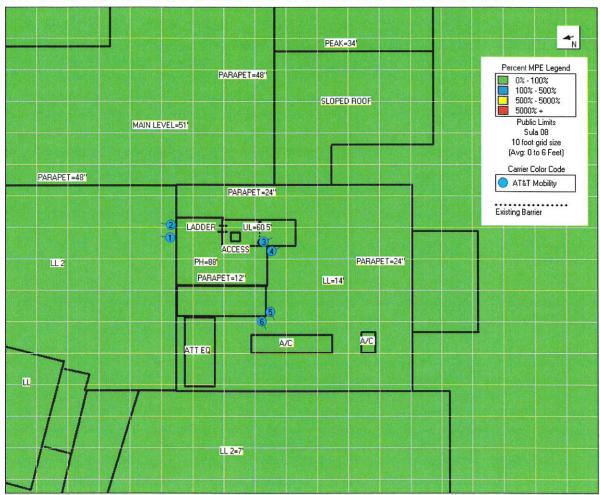

The reference plane for the plot is ground level.



5 Statement of Compliance

5.1 Statement of AT&T Mobility Compliance

At the time of our audit, AT&T Mobility is in **compliance** with the FCC's OET Rules and Regulations. No action is required.

5.2 Recommendations

No actions are required at this time.





6 Appendix A

6.1 Technical Framework

The FCC requires licensees to ensure that persons are not exposed to radiofrequency electromagnetic energy power densities in excess of the applicable MPE (Maximum Permissible Exposure) limits. These rules apply to both Occupational Personnel and the General Population. Applicable FCC rules are found at 47 C.F.R. § § 1.1307(b)(3) and 1.1310. The FCC rules define two tiers of permissible exposure differentiated by the situation in which the exposure takes place and/or the status of the individuals who are subject to exposure.

General Population / uncontrolled exposure limits apply to those situations in which persons may not be aware of the presence of electromagnetic energy, where exposure is not employment-related, or where persons cannot exercise control over their exposure.

Occupational / **controlled** exposure limits apply to situations in which persons are exposed as a consequence of their employment, have been made fully aware of the potential for exposure, and can exercise control over their exposure.


Maximum Permissible Exposure ("MPE") is defined in OET 65 as being 100% of the exposure limits for the situation or tier of permissible exposure. These limits are listed as follows:

Limits for Occupational/Controlled Exposure

		01100 = 211000011		
Frequency	Electric	Magnetic	Power	Averaging Time
Range (MHz)	Field	Field (H)	Density (S)	$ E ^2$, $ H ^2$ or S
100 B	Strength (E)	(A/m)	(mW/cm ²)	(minutes)
	(V/m)			
0.3-3.0	614	1.63	(100)*	6
3.0-30	1842/f	4.89/f	(900/f2)*	6
30-300	61.5	0.163	1.0	6
300-1500			f/300	6
1500-100,000			5	6


Limits for General Population/Uncontrolled Exposure

Frequency	Electric	Magnetic	Power	Averaging Time
Range (MHz)	Field	Field (H)	Density (S)	$ E ^2$, $ H ^2$ or S
, part (21) 19	Strength (E)	(A/m)	(mW/cm ²)	(minutes)
	(V/m)			
0.3-1.34	614	1.63	(100)*	30
1.34-30	842/f	2.19/f	(180/f2)*	30
30-300	27.5	0.073	0.2	30
300-1500			f/1500	30
1500-100,000			1.0	30

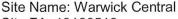

Site FA: 10133512



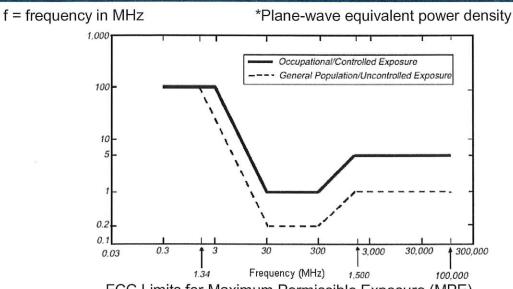


FCC Limits for Maximum Permissible Exposure (MPE)

Plane-wave Equivalent Power Density

For any area in excess of 100% General Population MPE, access controls with appropriate RF alerting signage must be put in place and maintained to restrict access to authorized personnel. Subject to other site security requirements, Occupational Personnel trained in RF safety and equipped with personal protective equipment designed for safe work in the vicinity of RF may be granted access. Controls such as physical barriers to entry imposed by locked doors, locked passageways, or other access control mechanisms may be supplemented by alarms that alert the individual and notify site management of a breach in access control. Controls may include administrative policies and procedures requiring personal protective equipment (e.g. RF personal monitor), proof of RF training to obtain site access cards, presentation of appropriate RF awareness training certifications to security personnel or other measures designed to prevent uncontrolled access.

RF alerting signs are not necessarily required, and by FCC guidelines, alone do not constitute compliance, posting of the appropriate **NOTICE**, **CAUTION**, or **WARNING** signs at areas of concern is considered good practice. The signs below are examples of signs meeting FCC guidelines.

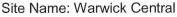

Site FA: 10133512












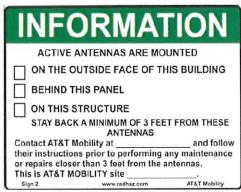





Power density decreases significantly over a short distance from any antenna. Specifically with respect to directional panel antennas, the design, orientation in azimuth and elevation as documented, reasonably precludes potential to exceed MPE limits at any location other than directly in front of the antenna. Areas in front of the antenna that are restricted by barriers, would require climbing or are otherwise beyond the reach of a standing individual of average height are not considered accessible. Analysis or measurement of instantaneous energy levels is performed for use as proof of compliance with FCC rules and regulations applicable to non-occupational persons, those individuals who are not authorized to access portions of the antenna support structure above ground level. To assess time-average exposure for occupational personnel working within secured areas of the site, on the



Site FA: 10133512

supporting structure, or in the immediate proximity of the antenna equipment is a separate study requiring detailed ergonomic information.

FCC regulations regarding Radiofrequency radiation exposure, expressed in 47 CFR § 1.1310 are further clarified with respect to the value of 5% of exposure limits for the subject transmitters in the following section of 47 CFR § 1.1307 (b):

(3) In general, when the guidelines specified in § 1.1310 are exceeded in an accessible area due to the emissions from multiple fixed transmitters, actions necessary to bring the area into compliance are the shared responsibility of all licensees whose transmitters produce, at the area in question, power density levels that exceed 5% of the power density exposure limit applicable to their particular transmitter or field strength levels that, when squared, exceed 5% of the square of the electric or magnetic field strength limit applicable to their particular transmitter. Owners of transmitter sites are expected to allow applicants and licensees to take reasonable steps to comply with the requirements contained In § 1.1307(b) and, where feasible, should encourage co-location of transmitters and common solutions for controlling access to areas where the RF exposure limits contained in § 1.1310 might be exceeded.

Following these FCC requirements, predictive modeling has been performed to evaluate power density resulting from client transmitters as a percentage of the power density MPE limit applicable to their transmitters. These results are presented in Section 4.

The site should be routinely inspected and this or a similar report updated with any changes to the RF environment including:

- Adding new antennas
- Removing of any existing antennas
- Change in the radiating power or number of RF emitters

Waterford Consultants recommends coordinating with all wireless tenants before performing services in front of or near any transmitting antennas. During these activities, it may be appropriate to utilize Lockout/Tagout Procedures as specified in ATT-002-290-078, "RF Exposure: Responsibilities, Procedures & Guidelines" for scheduled outages to eliminate RF hazards during these activities.

Site FA: 10133512



7 Appendix B

7.1 Qualifications of Waterford Consultants, LLC

With more than 100 team-years of experience, Waterford Consultants, LLC [Waterford] provides technical consulting services to clients in the Radio Communications and antenna locating industry. Waterford retains professional engineers who are placed in responsible charge of the processes for analysis.

Waterford is familiar with 47 C.F.R. § § 1.1307(b)(3) and 1.1310 along with the general Rules, Regulations and policies of the FCC. Waterford work processes incorporate all specifications of FCC Office of Engineering and Technology, Bulletin 65 ("OET65"), from the website: www.fcc.gov/oet/rfsafety and follow criteria detailed in 47 CFR § 1.1310 "Radiofrequency radiation exposure Limits".

Within the technical and regulatory framework detailed above, Waterford developed tools according to recognized and generally accepted good engineering practices. Permissible exposure limits are band specific, and the Waterford computerized modeling tools correctly calculate permissible exposure based on the band(s) specified in the input data. Only clients and client representatives are authorized to provide input data through the Waterford web portal. In securing that authorization, clients and client representatives attest to the accuracy of all input data.

Waterford Consultants, LLC attests to the accuracy of the engineering calculations computed by those modeling tools. Furthermore, Waterford attests that the results of those engineering calculations are correctly summarized in this report.



8 Appendix C

8.1 RoofMaster™

RoofMaster[™] is the software package that Waterford Consultants created to model RF environments associated with multiple emitters where the potential exists for human exposure. Based on the computational guidelines set forth in OET Bulletin 65 from the Federal Communications Commission (FCC), RoofMaster[™] considers the operating parameters of specified RF sources to predict the overall Maximum Permissible Exposure possible at a given location. These theoretical results represent worst-case predictions as emitters are assumed to be operating at 100% duty cycle.

From the FCC document:

"The revised OET Bulletin 65 has been prepared to provide assistance in determining whether proposed or existing transmitting facilities, operations or devices comply with limits for human exposure to radiofrequency (RF) fields adopted by the Federal Communications Commission (FCC). The bulletin offers guidelines and suggestions for evaluating compliance."

http://transition.fcc.gov/Bureaus/Engineering_Technology/Documents/bulletins/oet65/oet65.pdf

Site FA: 10133512



9 Appendix D

9.1 Statement of Limiting Conditions

Waterford Consultants has received data pertaining to RF environment provided by the client. Waterford Consultants will not be responsible for matters of a legal nature that affect the site or property. The property has been analyzed under the premise that it is under responsible ownership and management and our client has the legal right to conduct business at this facility.

Due to the complexity of some wireless sites, Waterford Consultants has created this report utilizing best industry practices and due diligence. Waterford Consultants cannot be held accountable or responsible for anomalies or discrepancies due to actual site conditions (i.e., mislabelling of antennas or equipment, inaccessible cable runs, inaccessible antennas or equipment, etc.) or information or data supplied by Wireless Carrier, the site manager, or their affiliates, subcontractors or assigns.

Waterford Consultants has provided the results of a computer generated model in this MPE Site Compliance Report to show approximate dimensions of the site, and the model results is included to assist the reader of the compliance report to visualize the site area, and to provide supporting documentation for Waterford Consultants' recommendations.

Waterford Consultants will not be responsible for any existing conditions or for any engineering or testing that might be required to discover whether adverse safety conditions exist. Because Waterford Consultants is not an expert in the field of mechanical engineering or building maintenance, this MPE Site Compliance Report must not be considered a structural or physical engineering report.

Waterford Consultants obtained information used in this MPE Site Compliance Report from sources that Waterford Consultants considers reliable and believes them to be true and correct. Waterford Consultants does not assume any responsibility for the accuracy of such items that were furnished by other parties.

EXHIBIT E



8002.NYCWNY4003 AT&T / BLACK & VEATCH

1/12/16

ANALYSIS OF EXISTING ANTENNA MOUNTS LTE 2C

SITE NAME

WARWICK CENTRAL FA#: 10133512

SITE ADDRESS

15 MAPLE AVENUE WARWICK, NY 10990

PURPOSE

ANALYSIS OF EXISTING ANTENNA MOUNTS LOCATED ON THE EXISTING ROOF.

DESIGN CRITERIA

- 1. ANTENNA MANUFACTURERS SPECIFICATIONS.
- 2. NEW YORK STATE BUILDING CODE.
- 3. ASCE 7-05.

ASSUMPTIONS

1. AS NOTED

REFERENCES

- 1. FIELD NOTES AND FIELD PICTURES
- 2. MANUAL OF STEEL CONSTRUCTION (AISC 14TH EDITION)
- 3. DRAWINGS BY TECTONIC DATED 03-29-2013.
- 4. STRUCTURAL BY TECTONIC DATED 06-28-12.

PROCEDURE

- CALCULATE THE LOADS TO BE RESISTED.
- 2. CHECK MEMBER STRESSES TO RESIST LOADS.
- 3. CHECK SUPPORTING BUILDING ELEMENTS.
- 4. CHECK CONNECTIONS.


RESULTS/CONCLUSIONS

THE EXISTING ANTENNA MOUNTS ARE ADEQUATE TO SUPPORT THE PROPOSED INSTALLATION. THE EXISTING STRUCTURE IS ADEQUATE TO SUPPORT THE ANTENNA UPGRADE.

CONTRACTOR SHALL FIELD VERIFY EXISTING CONDITIONS AND RECOMMENDATIONS AS NOTED ON THE CONSTRUCTION DRAWINGS AND NOTIFY THE DESIGN ENGINEER OF ANY DISCREPANCIES PRIOR TO CONSTRUCTION, ANY FURTHER CHANGES TO THE ANTENNA AND/OR APPURTENANCE CONFIGURATION SHOULD BE REVIEWED WITH RESPECT TO THEIR EFFECT ON STRUCTURAL LOADS PRIOR TO IMPLEMENTATION.

PREPARED BY:	J. VASSELL	DATE;	01/09/16
REVIEWED BY:	E. JAMICELI	DATE:	01/12/2016



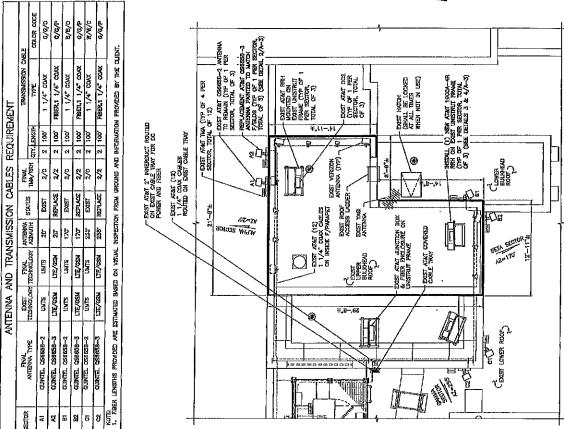

NEW ANTENNA PLAN



Job No. 8002.NYCWNY4003

Sheet No.

of

Calculated By JV Date: 01/09/16 Checked By EI Date: 01/12//6

Title:

<u>CALCULA</u> 7	TON OF W	IND LO	DAD ON	I ANTENNA - REV-F
Antenna Information:				
Model No. =		6658-3		
Height =	72	in		
Width =	12	in	-	
Depth =	9,6	in		
Area, Aa =	2,96	ft2	Per	Manuf.
Weight =	77	lbs		
Antenna Centerline =	87.00	ft	·. · · · ·	
Geographic Information:				
County:	ORANGE			-
Wind Speed =	70	mph	PER	Rev. F
Supporting Pipe Information	<u>. </u>			
Pipe Length =	7	ft		
	2 1/2" PIPE			
Width =	2.875	in		
Area =	1.59	in		
Weight =	5.79	lb/ft		WWW.
Design Parameters:			 	
Per, TIA/EIA-222-F-1996:				
Design Wind Load, $F = q_z G_H$	$(C_A A_A)$			
q_{z}	16.5	5 psf		
κ _z =	1.3	2 ft		
G _{H=}	1.1	7		$G_{H=}$ 1.1724
Antenna C _A =	1.40	0		
Pipe C _A =	1.:	2		
Normal Force on Antenna, F _N =	RI	0 lbs		
Fransverse Force on Antenna, $F_T = \frac{1}{2}$		O Ibs		
•				C LDC/FT
Force on Pipe F _A =	39	9 lbs		6 LBS/FT

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OFFICES:
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Richmond, VA Albany, NY

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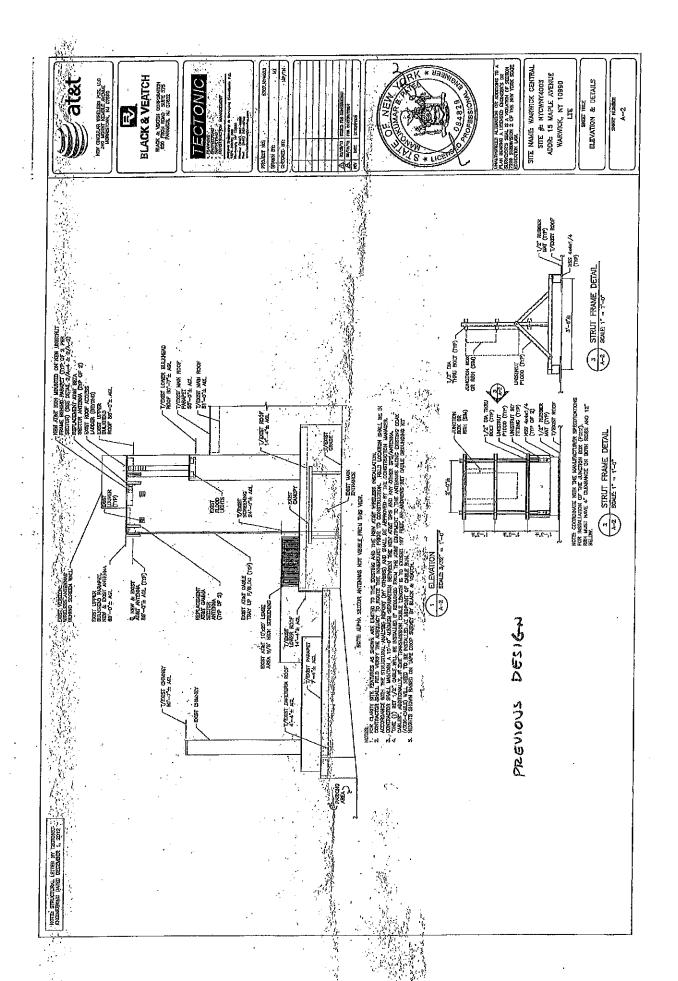
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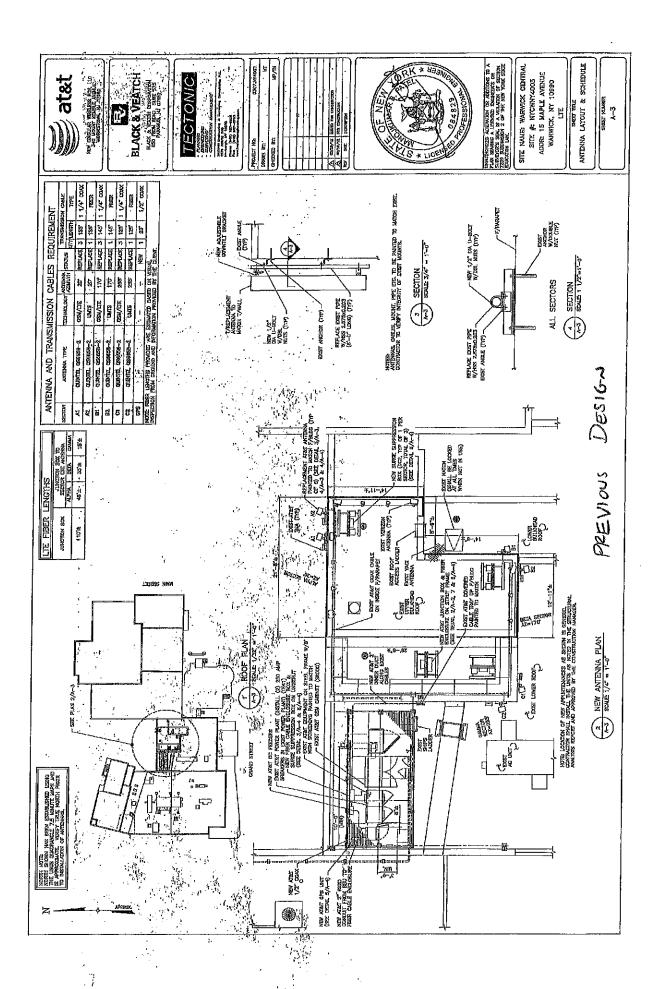
Mountainville, NY New York, NY
Richmond, VA Albany, NY
Hartford, CT Saddle Brook, NJ
Tempe, AZ Tampa, FL
Albuquerque, NM (800) 829-6631

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ANTENNA SPEC

QS6658-3

MultiServ

6ft 65° XXX WultiServ™ 8-Port Antenna

2x698-787MHz / 2x824-894MHz / 2x1710-2400MHz / 2x1710-2400MHz




- Provides 8 antenna Ports in a slim-line form factor
- Optimized Azimuth patterns for Min Inter-Sector Interference
- Industry leading Minimal Wind-Load design

- ▼ 700, 850, PCS, AWS & WCS bands in one antenna
- AISG & 3GPP compliant internal remote electrical tilt (RET)

The Quintel MultiServ[™] Multiband 8 Port Antenna with patented QTilt[™] technology uniquely delivers four independent services in a single slim-line antenna. This enables existing antenna network sites to be upgraded constraint free to add new services such as LTE for 700, 850, PCS, AWS and WCS bands with the replacement of one antenna. The QS6658-3 also provides 4x 1710-2400MHz ports as two side-by-side (CLA-2X) arrays, each array having independent tilt to support independent service, or for connection to 2T4R/4T4R service.

Electrical Characteristics	2x Ports 1&2	2x Ports 3&4		2x Pa 2x Pa	rts 5&6 rts 7&8	
Operating Frequency (MHz)	698-787	824-894)-2400)-2400	
	698-787	824-894	1710-1780	1850-1990	2110-2180	2300-2400
Azimuth beamwidth ¹	69°	63°	70 ⁰	70°	62 ⁰	58°
Elevation beamwidth ^t	12°	100	6,2 ⁰	5.9 ⁰	5.2 ⁰	4.7 ⁰
Gain! (dBl)	13.5	14.0	17.0	17.0	17.5	18.0
Polarization	±45°	±45 ⁰ .		an are a charge of the Constraint	45 ⁰ 45 ⁰	
Electrical down-till range	2 ⁰ -10 ⁰	2 ⁰ .10 ⁰	le en propa est		- 10° - 10°	ga ja sa sa sa sa sa sa sa sa sa sa sa sa sa
Upper SLL (20° > malnbeam) 1	-16dB	-16dB	-16dB	-16dB	-17dB	-15dB
Front to Back Ratio(180°±10°)¹	≥30dB	≥30dB	≥30dB	≥30dB	≥30dB	≥30dB
Port to Port Isolation ^t	≥30dB	≥28dB	≥30dB =	≥30dB	= ≥30dB	≥30dB
Return loss (VSWR) Squint ¹	14dB(1.5) <±3 ^o	14dB(1.5) <±2 ^o	14dB(1.5) <±3°	14dB(1,5) <±3 ⁰	14dB (1.5) <±3 ⁰	14dB(1.5) <±3 ⁰
Tracking ¹	<±2dB	<±2.5dB	<±3dB	<±3dB	<±3dB	<±3dB
X Polar Discrimination (at 0 ⁰)	>20dB	>20dB	>19dB	>18dB	>16dB	>17dB
Power handling (per port)	500 watts	500 watts		250	walls	
PIM (3 rd Order) (2x43dBm)	>153dBc	>153dBc		≻15	3dBc	

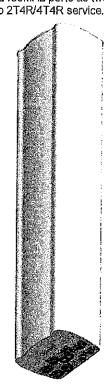


¹ Typical Performance	200000	fromuanou	and I	Townfill.
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Dimensions	L 72"(1828mm) x.W 12"(304mm) x D 9.6"(245mm)
Weight (excl mounting brackets)	77/bs (35kg)
No. of Connectors	8x 7/16 DIN Female Long Neck
Max Wind Speed	150mph (67m/s)
Equivalent Flat Plate Area	2.96ft ² (0.275m ²
Wind Load @160km/h (45m/s)	Front: 587N (132 lbs), Side: 382N (86 lbs)

AISG Standards	V1.1,V 2.0 and 3GPP
Factory Default	AISG 2.0
Surge immunity	IEC 61000 4-5:2005 4KV(AISG PIN)
Device Type	SRETType 1
AISG Data rate	9.6 kbps
No of connectors	11in, 1out a second as Foreign Consumer of the con-
Connector type	IEC 60130-9 (Ed 3.0)
MTBF	36,000 Operational moves

All specifications are subject to change without notice. Please contact your Quintel representative for complete information.

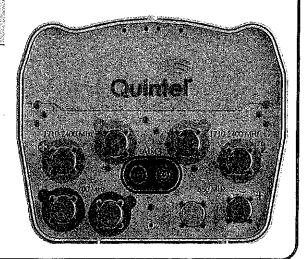

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